

January 8, 2015

Ref: 29011.00

Mr. Michael Sassi, P.E. Regional Highway Work Permit Coordinator New York State Department of Transportation 4 Burnett Boulevard Poughkeepsie, NY 12603

Re: MDP and Site Plan Phase 1 Comments Silo Ridge Resort Community Amenia, NY

Dear Mr. Sassi:

On behalf of our client, Silo Ridge Ventures, LLC., "the Applicant", VHB Engineering, Surveying and Landscape Architecture, P.C. (VHB) offers the following responses to your comments dated October 17, 2014 (numbered in accordance with your letter).

Conceptual Comments

1. Comment: The project proposes a main entrance on RTE 22 employing a dual egress alignment. The Applicant has submitted Synchro (traffic modeling software) files showing the projected level of service overall and for individual turning movements. Upon review, it is found that the operation of the proposed intersection is acceptable for all turning movements with the exception of the eastbound left turn out (northbound) from the development. This turning movement is shown in the model to operate at a level service, "F", which is generally found to be an unacceptable level of service because of the long delay. From a state highway perspective, the concern is that motorists may become impatient turning left when it not safe to do so. As such, the Applicant is asked to consider alternate means of northbound egress, propose a restriction of this movement, or otherwise justify the movement from an operational and safety perspective.

Response: Subsequent to VHB's August 12, 2014 submission to NYSDOT, the phasing of the project has been modified, with more development occurring in Phase 1. VHB has updated the trip generations, volume projections and analyses based on the change in development and provides justification for the left-turn exiting movement, as described in the following.

50 Main Street

Suite 360

White Plains, New York 10606

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The Silo Ridge development's residential component will be exclusively for second-home ownership. As such, VHB has reviewed available trip generation data to determine the appropriate residential trip rates to use in the analysis. Research data (attached) indicates that second-home residences generate between 26 and 38 percent of the trip rates for single-family homes contained in the ITE *Trip Generation Manual, Ninth Edition*. A review of the range of peak hour trip rates for ITE Land Use Code 210 ("Single-Family Detached Housing") indicates that the lowest surveyed rates constitute less than 48 percent of the average ITE trip rate. Based on this information, it is realistically anticipated that the Silo Ridge residential homes will only generate half as much traffic as projected by ITE for primary residences and as evaluated in the previous study dated March 12, 2014. The previous analysis was revised to reflect the lower anticipated residential trip generation rates. The revised trip generations for the Silo Ridge Modified Project are indicated in Table 1.

Table 1 - Peak Hour Trip Generation

		AM Peak Hour			PM Peak Hour			Saturday Peak Hour		
Development	Size	Total Trips ⁽¹⁾	Internal Trips	New Trips	Total Trips ⁽¹⁾	Internal Trips	New Trips	Total Trips ⁽¹⁾	Internal Trips	New Trips
Phase 1										
Single Family	141 du	61	-7	54	82	-11	72	79	-12	67
Condo/Townhouses	65 du	23	-5	18	28	-6	22	39	-8	31
Hotel	21 units	11	-3	8	13	-4	8	15	-5	10
Golf Course & Clubhouse (2)	18 holes	34	-15	19	48	-21	28	57	-25	32
Total Phase 1		129	-29	100	171	-42	129	190	-49	141
Full Build-out										
Single Family	159 du	68	-8	60	91	-11	80	88	-13	75
Condo/Townhouses	65 du	23	-5	18	28	-7	21	39	-8	31
Hotel	21 units	11	-3	8	13	-5	8	15	-5	10
Golf Course & Clubhouse	18 holes	37	-16	21	53	-23	30	62	-27	35
Winery Restaurant (3)	80 seats	2	0	2	21	0	21	14	0	14
Total Full Build-out		142	-32	110	205	-46	159	218	-53	165

Notes: (1) For Single-family and Condo/Townhouse trips, values shown reflect 50% of ITE values, plus internal trips to golf and hotel (subsequently subtracted, leaving rates for new traffic added to off-site roadways equivalent to 50% of ITE rates).

⁽²⁾ Phase 1 Golf Course trips estimated to be 92% of full build-out trips as majority of golf trips will be from residential component which is not fully built in Phase 1.

⁽³⁾ Midday Saturday Winery restaurant trips are 75% of Saturday Peak generator hour (evening) trips.

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As indicated in Table 1, at full build-out, the project will generate 110 new trips during the AM peak hour, 159 new trips in the PM peak hour and 165 new trips during the Saturday midday peak hour. For Phase 1, the project is projected to generate approximately 14% less traffic than it will at full build-out.

The trips shown in Table 1 were distributed to the roadways and then added to the previously established 2017 No-Build volumes. It was assumed all trips from the southern/main parcel of the site would utilize the Main driveway and that the southern site driveway on Route 22 would be for emergency access and for access to the site's wastewater treatment plant and golf maintenance facility. Unsignalized intersection capacity analyses were conducted using Synchro software (version 8) for the Build condition during the PM peak hour (the critical time frame for the full build-out of the project). The analysis was performed at the Main site driveway on Route 22 assuming the existing geometry and a new northbound left-turn lane on Route 22. The results of this analysis indicate that the eastbound left turn exiting the driveway will operate at Level of Service (LOS) "E" with delays of 47.1 seconds and a volume to capacity ratio (v/c) of 0.40. All other movements will operate at LOS "B" or better.

After the completion of Phase 1, peak hour surveys will be conducted at the driveway to confirm that the average delay exiting the site does not fall below the projected LOS E. If the surveys indicate that excessive delays are experienced on the exiting movements, the Applicant will consider permitting residents to exit at the secondary (southern) access driveway. Appropriate permits will be filed at that time, if necessary.

2. Comment: It is our understanding that while at one time a right turn lane into the development was considered, it is no longer required or requested at the main entrance. This is acceptable and found to improve the projected operation of the left turn out (if justified) while not reducing the level of service on the RTE 22 main line.

Response: Comment noted.

3. Comment: At one time, it was understood that a fill operation was planned within the right-of-way at either side of the main entrance. This is not evident on the plans. A confirmation is requested.

Response: The area of fill proposed within the right-of-way is adjacent to the main entrance on Route 22, as shown in plan view on drawing GP-1, General Plan 1 and GP-2, General Plan 2, dated January 8, 2015. Cross sections have been taken at four locations at the main entrance, as shown on drawing

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Miscellaneous Details 3, dated January 8, 2015. The applicant intends to import the necessary fill along Route 22 which will adhere to the local, state and federal requirements accordingly, however, if fill from within the project site is intended to be used, it will be testing to assure compliance with all applicable standards.

4. Comment: In reference to Drawings 4 and 6A, steep slopes are shown. The Vineyard Cottage drainage along RTE 44 is a concern as compounded by additional traffic generation. Accordingly, the north side of RTE 44 will require cutting back the slope, installing drainage facilities (closed system or ditch lines), and creation of a shoulder. The segment of improvement should begin at the proposed entrance to the Vineyard Cottage and continue to below the proposed wastewater plant and beyond.

Response: The proposed curbed road at the Vineyard Cottage and winery will intersect the flow from the uphill area thus reducing the contributing drainage area and runoff to Route 44. The increase of runoff from the proposed development will flow into the proposed closed drainage system and eventually drain into the proposed detention basin. The proposed detention basin will route and detain the flow to reduce the peak rate of flow ranging from 1-year to 100-year to match the existing flow rate before crossing Route 44. The proposed development at the Vineyard Cottage and Winery thus will not negatively impact Route 44. The applicant agrees to create a swale at the west side of Route 44 and downhill of the winery where grading is more accessible to further reduce the runoff from getting onto Route 44 and minimize potential environmental impacts to steep slopes.

5. Comment: Show sight distance triangles on the plans for all turning movements at all entrances. Provide a matrix at each location detailing required sight distance for each type of movement and available sight distance.

Response: Sight distance triangles and matrices indicating available and required sight distances at each location have been included on Drawings SD-1 and SD-2, dated January 8, 2015.

6. Comment: The proposed emergency entrance must not be a "Boulevard Entrance". It should be simply planned accommodating the design vehicle. A locked and gated access must clearly be shown on the plans. This emergency entrance must not be available for daily use of development occupants.

Response: The emergency entrance on Route 44 has been redesigned as requested and is shown as "gate with key card access for emergency access only" on the revised plans (please refer to Drawing GP-3, dated January 8, 2015).

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7. Comment: The winery/residential/lookout entrance to RTE 44 must be detailed as a minor commercial entrance.

Response: The winery/residential/lookout entrance on Route 44 has been detailed as a minor commercial entrance (as indicated on drawing GP-4B, General Plan 4 – MDP, dated January 8, 2015).

8. Comment: The existing RTE 44 pull-off area should be closed with guiderail.

Response: The plan set has been updated to provide a guiderail at the Route 44 pull-off area (please refer to drawings GP-4A, General Plan 4 – Phase 1, and GP-4B, General Plan 4 – MDP, dated January 8, 2015).

9. Comment: All highway improvement drawings must show a labeled State Right-of-Way boundary.

Response: The State right-of-way boundary has been shown and labeled on all highway improvement drawings (sheets GP-1 through GP-6, General Plans 1-6, dated January 8, 2015).

10. Comment: Please offer confirmation that the gate shown on drawing GP-7 is on private lands.

Response: The gate shown on drawing GP-6 (formerly GP-7) is on private lands, as indicated by its location relative to the right-of-way boundary line on drawing GP-6, General Plan 6, dated January 8, 2015).

11. Comment: For drainage submissions please provide more detailed plans showing the watershed boundaries (with contours) and flow paths. The 11" x 17" plans provided in the SWPPP will not suffice.

Response: More detailed plans indicating the watershed boundaries (with contours) and flow paths have been provided (please refer to Existing Conditions Drainage Area Map, Fig 1 and Proposed Conditions Drainage Map, Fig 2, dated January 8, 2015).

12. Comment: All design storms must be considered (not only the 100 yr).

Response: The 1-, 5-, 10-, 25- and 50-year storms have been analyzed in addition to the 100-year storm (please refer to attachment E2 in SWPPP for Hydrocad analyses output).

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13. Comment: Existing ponds or other features to be retained need to be described and included in the analysis.

Response: The existing ponds and other water features that are being retained as part of the Modified Project were labeled and modeled in drainage area maps and HydroCAD models. They were typically labeled as a "number within a triangle" symbol as shown in the legend of the drainage area maps. Pond D was labeled and modeled as "104A" in the drainage area maps as well as HydroCAD models.

14. Comment: Information on the culvert under RTE 22 at the southern end should be provided.

Response: Existing information for the 18" RCP pipe under Route 22 at the south entrance has been added to the plan, please refer to Drawing, GP-6.

15. Comment: Explain/show the drainage overflow (GP-6x).

Response: The grading downstream of the existing 24" pipe crossing Route 44 has been revised such that in the case of a drainage system failure, runoff will sheet flow downstream toward the golf course area without backing up onto the ROW.

16. Comment: Define the utility permit request operation in a separate application. If crossings are needed for private utilities, a Use & Occupancy permit may be required. If public utility services are intended, it is expected that the utility will apply for the permit. Please telephone or email for additional guidance.

Response: The utility permit request operation will be provided in a separate application. Public utility services are intended and the Applicant will coordinate with the utility provider on the permit application.

Project Development Guidance Comments

17. Comment: In reference to Drawing 3, there is concern about the proposed crossings under RTE 44 and depth relative to existing pipes. The ownership, depth, and condition of existing facilities must be confirmed.

Response: The wastewater treatment plant ("WWTP") has been relocated to the south to the Golf Maintenance Facility area on the Harlem Valley Landfill Corp. property and the proposed crossings under Route 44 at that location have thus been removed. As such, the sheet formerly labeled as GP-3 has been removed. The new location of the Wastewater Treatment Plan can be seen on Drawing GP-6, dated January 8, 2015.

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18. Comment: Detailed entrance plans must be submitted for each proposed entrance as design development advances.

Response: Detailed entrance plans for the main entrance and emergency entrances on Route 22 are provided on drawings GP-1, General Plan 1, GP-2, General Plan 2, and GP-6, General Plan 6, dated January 8, 2015. As the design development advances for the Route 44 entrances, plans will be forwarded to NYSDOT.

19. Comment: Specify guiderail end sections. It may not be appropriate to reuse existing.

Response: New Guide rail end sections are to be installed in accordance with NYSDOT Standards and have been specified on the plans, as indicated on sheets GP-4A, General Plan 4 Phase 1, GP-4B, General Plan 4 MDP, General Plan 5 Option 1, and General Plan 6, Option 2.

20. Comment: Signage is required westbound in addition to that shown on Dwg 5A.

Response: The appropriate westbound signage has been added to drawing 4A (formerly 5A).

21. Comment: One of the proposed Sugar Maples appears to be located within the clear distance (w/in 30' of the travel way). This tree should be moved so that is a minimum 30' from the white line.

Response: The tree has been relocated to be greater than 30 feet from the white line, as indicated on sheet GP-1, General Plan 1, dated January 8, 2015.

22. Comment: Align the detail for pavement thickness for work on State highways with standard details.

Response: The detail for pavement thickness for work on State highways has been aligned with the standard details, please refer to sheet MD-1, Miscellaneous Details 1, dated January 8, 2015.

23. Comment: In reference to Drawing 2, the condition of the large cross culvert on RTE 22 must be confirmed. This culvert is located north of the proposed main entrance on RTE 22.

Response: VHB performed an inspection of the large cross culvert under Route 22 in December 2014. Please refer to VHB Memorandum dated January 13, 2015, (Attachment B), which provides a detailed assessment of the condition of the culvert. As indicated in the Memo, the structure is in overall fair condition, with some areas exhibiting spalling. The structure was last inspected by

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NYSDOT on October 24, 2013 when it received a condition rating of 5.29 on a scale of seven (7.0), with seven being new or like new construction.

24. Comment: The Applicant shall satisfactorily complete the Smart Growth Prescreening Tool required under the NYS Smart Growth Public Infrastructure Policy Act (SGPIPA).

Response: The Smart Growth Prescreening Tool has been completed – please refer to Attachment A.

25. Comment: This project is subject to the requirements of the State's Drivers First initiative. Delay to the traveling public must be minimized.

Response: Comment noted. During construction, delays to the traveling public on Routes 22 and 44 will be minimized to the extent possible. Construction activity that would impact the flow of traffic will be scheduled so as to avoid impacts during the peak travel periods, typically the weekday AM and PM commuter periods.

26. Comment: The Applicant's resubmission should include enumerated comments noting sheet, date, detail no., etc. Each revision is to be clouded (or otherwise called out) with a revision number. Furthermore, any substantive revisions not related to NYSDOT comments must be clouded (or otherwise called out) and noted in the re-submittal letter.

Response: The response contained herein are numbered in accordance with the comment letter and references to sheet number, date, detail number, etc. are provided where appropriate. Each revision, including revisions for substantive non-NYSDOT comments, has been clouded and labeled with a revision number.

27. Comment: Future submissions shall be electronic (PDF) with two paper copies to the Poughkeepsie office and one paper copy to the Middletown office of the following:

Regional Permit Coordinator NYS Department of Transportation 4 Burnett Boulevard Poughkeepsie, NY 12603 Permit Engineer, residency 8-2 NYS Department of Transportation 334 Violet Avenue Poughkeepsie, NY 12601

Response: Comment noted.

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Sincerely,

Amanda DeCesare, PE

Senior Project Manager

Gmanda De Cesare

adecesare@vhb.com

CC: Chairman Fontaine and Members of the Planning Board;

David Everett, Esq.; Peter Wise, Esq.; and

Pedro Torres

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Attachment A: Smart Growth Screening Tool

			PIN
Prepared By	7 •		
Smart Grow	th Screen	ing Tool (STEP 1)	
STOP for the proj	ect type und		ening Tool until the directions indicate to projects, complete answering the ce document.
Title of Proposed	Project:		
Location of Project	ct: Amenia, D	utchess Co., NY	
		-	lane on NYS 22 to support the of a 215-unit vacation community.
A. Infrastruc	cture:		
	ects for the u		ent of existing infrastructure) existing infrastructure?
Yes ⊠	No 🗌	N/A 🗌	
Explain: (use the length of your	•	xpand on your answers above	e – the form has no limitations on the
Uses ex	isting roads f	or access and existing power I	lines for electricty supply

Maintenance Projects Only

- a. Continue with screening tool for the four (4) types of maintenance projects listed below, as defined in **NYSDOT PDM Exhibit 7-1 and described in 7-4:** https://www.dot.ny.gov/divisions/engineering/design/dqab/pdm
 - Shoulder rehabilitation and/or repair;
 - Upgrade sign(s) and/or traffic signals;

- Park & ride lot rehabilitation;
- ⇒ 1R projects that include single course surfacing (inlay or overlay), per Chapter 7 of the NYSDOT Highway Design Manual.
- b. For all other maintenance projects, **STOP here.** Attach this document to the programmatic <u>Smart</u> <u>Growth Impact Statement and signed Attestation</u> for Maintenance projects.

For all other projects (other than maintenance), continue with screening tool.

B. Sustainability:

NYSDOT defines Sustainability as follows: A sustainable society manages resources in a way that fulfills the community/social, economic and environmental needs of the present without compromising the needs and opportunities of future generations. A transportation system that supports a sustainable society is one that:

- → Allows individual and societal transportation needs to be met in a manner consistent with human and ecosystem health and with equity within and between generations.
- ⇒ Is safe, affordable, and accessible, operates efficiently, offers choice of transport mode, and supports a vibrant economy.
- ⇒ Protects and preserves the environment by limiting transportation emissions and wastes, minimizes the consumption of resources and enhances the existing environment as practicable.

For more information on the Department's Sustainability strategy, refer to Appendix 1 of the Smart Growth Guidance and the NYSDOT web site, www.dot.ny.gov/programs/greenlites/sustainability

(Addresses SG Law criterion j: to promote sustainability by strengthening existing and creating new communities which reduce greenhouse gas emissions and do not compromise the needs of future generations, by among other means encouraging broad based public involvement in developing and implementing a community plan and ensuring the governance structure is adequate to sustain and implement.)

	ipieiii	enc.)				
1.	Will t	his projec	t promote sus	tainability by stren	ngthening existing communities?	
	Yes		No 🗌	N/A		
2.	Will t	the project	t reduce green	nhouse gas emissio	ons?	
	Yes		No 🗌	N/A		
	Expla	ain: (use tl	his space to ex	pand on your answ	wers above)	
	fro	ending in om New Y	the Town. Pro ork City will r	oviding a vacation edcue greenhouse	wn of Amenia by increasing the tax base an community at the end of the commuter rail ling gases which would otherwise be emmitted be do not have access to mass transit. Roadwa	e y

improvements and driveways will allow the development to operate satisfactorily.

C. Smart Growth Location:

Plans and investments should preserve our communities by promoting its distinct identity through a local vision created by its citizens.

(Addresses SG Law criteria b and c: to advance projects located in municipal centers; to advance projects in developed areas or areas designated for concentrated infill development in a municipally approved comprehensive land use plan, local waterfront revitalization plan and/or brownfield opportunity area plan.)

1.	Is this project loc	ated in a devel	oped area?
	Yes	No 🖂	N/A
2.	Is the project loc	ated in a munic	ipal center?
	Yes	No 🛛	N/A
3.	Will this project f	oster downtov	n revitalization?
	Yes 🖂	No 🗌	N/A
4.	in a municipally a Brownfield Oppo	pproved comp	located in an area designated for concentrated infill development rehensive land use plan, waterfront revitalization plan, or an?
	Yes	No 🖂	N/A
	Explain: (use this	s space to expa	nd on your answers above)
			influx of families on weekend getaways supported by this e revitalization of the Town's central business district.

D. Mixed Use Compact Development:

Future planning and development should assure the availability of a range of choices in housing and affordability, employment, education transportation and other essential services to encourage a jobs/housing balance and vibrant community-based workforce.

(Addresses SG Law criteria e and i: to foster mixed land uses and compact development, downtown revitalization, brownfield redevelopment, the enhancement of beauty in public spaces, the diversity and affordability of housing in proximity to places of employment, recreation and commercial

development and the integration of all income groups; to ensure predictability in building and land use codes.) 1. Will this project foster mixed land uses? No 🗌 Yes X N/A 2. Will the project foster brownfield redevelopment? Yes 🗌 No 🖂 N/A 3. Will this project foster enhancement of beauty in public spaces? No \square N/A Yes 🖂 4. Will the project foster a diversity of housing in proximity to places of employment and/or recreation? Yes No 🖂 N/A 5. Will the project foster a diversity of housing in proximity to places of commercial development and/or compact development? Yes \square No 🖂 N/A 6. Will this project foster integration of all income groups and/or age groups? Yes \square No 🖂 N/A 7. Will the project ensure predictability in land use codes? Yes \square No 🖂 N/A 8. Will the project ensure predictability in building codes? Yes X No \square N/A **Explain:** (use this space to expand on your answers above) Overall project is being designed to preserve and enhance the beauty of the valley, including the addition of a scenic overlook. Proposed highway improvements will comply

E. Transportation and Access:

NYSDOT recognizes that Smart Growth encourages communities to offer a wide range of transportation options, from walking and biking to transit and automobiles, which increase people's access to jobs, goods, services, and recreation.

(Addresses SG Law criterion f: to provide mobility through transportation choices including improved public transportation and reduced automobile dependency.)

with all applicable codes, thereby supporting their continued predictability.

1.			
	Will this project p	orovide public	ransit?
	Yes 🖂	No 🖂	N/A
2.	Will this project e	enable reduced	automobile dependency?
	Yes 🖂	No 🗌	N/A
3.	•	es, lane striping	e and pedestrian facilities (such as shoulder widening to provide for g, crosswalks, new or expanded sidewalks or new/improved
	Yes	No 🖂	N/A
	requires that cor	nsideration be a construction ar	on on question 2. The recently passed Complete Streets legislation given to complete street design features in the planning, design, and rehabilitation, but not including resurfacing, maintenance, or jects.)
	Explain: (use this	s space to expa	nd on your answers above)
	Redevelopi station.	ment project v	vill provide a shuttle for residents and employees to the train
F	'. Coordinat	ed, Comn	nunity-Based Planning:
Pa le ba	ast experience has ads to better deci	s shown that easions and more	nunity-Based Planning: arly and continuing input in the transportation planning process e effective use of limited resources. For information on community may be a good resource if the project is located within the MPO
Pa le ba pl (A	ast experience has ads to better deci ased planning effo anning area. Addresses SG Law	s shown that ex sions and more orts, the MPO r criteria g and h	arly and continuing input in the transportation planning process effective use of limited resources. For information on community
Pa le ba pl (A m	ast experience has ads to better deci ased planning effo anning area. Addresses SG Law unicipal and regio	s shown that ex sions and more orts, the MPO r criteria g and h anal planning; t	arly and continuing input in the transportation planning process e effective use of limited resources. For information on community nay be a good resource if the project is located within the MPO at to coordinate between state and local government and inter-
Pa le ba pl (A m	ast experience has ads to better deci ased planning effo anning area. Addresses SG Law unicipal and regio	s shown that ex sions and more orts, the MPO r criteria g and h anal planning; t	arly and continuing input in the transportation planning process e effective use of limited resources. For information on community nay be a good resource if the project is located within the MPO at to coordinate between state and local government and interportation participate in community based planning and collaboration.)
Pa le ba pl (A m	ast experience has ads to better deci ased planning effo anning area. Addresses SG Law unicipal and regio Has there been p	s shown that exsions and more orts, the MPO recriteria g and he mal planning; to participation in	arly and continuing input in the transportation planning process e effective use of limited resources. For information on community nay be a good resource if the project is located within the MPO at to coordinate between state and local government and interpolation participate in community based planning and collaboration.) community-based planning and collaboration on the project? N/A
Pa le ba pl (A m	ast experience has ads to better deciposed planning efformation and resses SG Law unicipal and region Has there been possible.	s shown that exsions and more orts, the MPO recriteria g and he mal planning; to participation in	arly and continuing input in the transportation planning process e effective use of limited resources. For information on community nay be a good resource if the project is located within the MPO at to coordinate between state and local government and interpolation participate in community based planning and collaboration.) community-based planning and collaboration on the project? N/A
Pa le ba pl (A m	ast experience has ads to better decire ased planning efformation and region and region has there been project cores something the project cor	s shown that exisions and more orts, the MPO recriteria g and honal planning; to participation in No	arly and continuing input in the transportation planning process effective use of limited resources. For information on community may be a good resource if the project is located within the MPO at to coordinate between state and local government and interpo participate in community based planning and collaboration.) community-based planning and collaboration on the project? N/A Cal plans?

4. Has proj		ordin	ation betw	veen i	inter-municipal/regional planning and state planning on the
Yes		No		N/A	
Expl	ain: (use this	space	to expand	l on y	our answers above)
W	Overall proje		_	_	n the SEQRA process with public input and coordination ncies.
G. S	tewardsh	ip o	f Natu	ral	and Cultural Resources:
for Nev assets,	w York State r	esidei ice, pr	nts, visitor omoting e	s, and nerg	nd are essential elements of public health and quality of life d future generations. Restoring and protecting natural y efficiency, and green building, should be incorporated into ecisions.
agricul	tural land, for	ests s	urface and	grou	r, preserve and enhance the State's resources, including and water, air quality, recreation and open space, scenic ogical resources.)
ı. Will	the project pr	otect,	, preserve,	and/	or enhance agricultural land and/or forests?
Yes		No	\boxtimes	N/A	
			•		or enhance surface water and/or groundwater?
Yes	_	No		N/A	
			•		or enhance air quality?
Yes		No		N/A	
					or enhance recreation and/or open space?
Yes		No		N/A	
5. Will	the project pr	otect,	, preserve,	and/	or enhance scenic areas?
Yes		No		N/A	
6. Will	the project pr	otect	, preserve,	and/	or enhance historic and/or archeological resources?
Yes		No		N/A	
Expl	ain: (use this	space	to expand	l on y	our answers above)

Overall project will employ best practices water management, will preserve scenic beauty of the golf course and the valley. Developemnt will respect existing archiological resources.

Smart Growth Impact Statement (STEP 2)

NYSDOT: Complete a Smart Growth Impact Statement (SGIS) below using the information from the Screening Tool.

Local Sponsors: The local sponsors are **not** responsible for completing a Smart Growth Impact Statement. Proceed to **Step 3**.

Smart Growth Impact Statement

PIN:

Project Name:

Pursuant to ECL Article 6, this project is compliant with the New York State Smart Growth Public Infrastructure Policy Act. This project has been determined to meet the relevant criteria, to the extent practicable, described in ECL Sec. 6-0107. Specifically, the project:

This publically supported infrastructure project complies with the state policy of maximizing the social, economic and environmental benefits from public infrastructure development. The project will not contribute to the unnecessary costs of sprawl development, including environmental degradation, disinvestment in urban and suburban communities, or loss of open space induced by sprawl.

Review & Attestation Instructions (STEP 3)

Local Sponsors: Once the Smart Growth Screening Tool is completed, the next step is to submit the project certification statement (Section A) to Responsible Local Official for signature. After signing the document, the completed Screening Tool and Certification statement should be sent to NYSDOT for review as noted below.

NYSDOT: For state-let projects, the Screening Tool and SGIS is forwarded to Regional Director/RPPM/Main Office Program Director or designee for review, and upon approval, the attestation is signed (Section B.2). For locally administered projects, the sponsor's submission and certification statement is reviewed by NYSDOT staff, the appropriate box (Section B.1) is checked, and the attestation is signed (Section B.2).

A. CERTIFICATION (LOCAL PROJECT)

I HEREBY CERTIFY, to the best of my knowledge, all of the above to be true and correct. Preparer of this document:

rreparer or this document.	
Signature	Date
Title	Printed Name
Responsible Local Official (for local projects):	
Signature	Date
 Title	Printed Name

B. ATTESTATION (NYSDOT)

1.	. I HEREBY:								
	☐ Concur with the above certification, thereby atte with the State Smart Growth Public Infrastructure	• ,							
	 Concur with the above certification, with the following conditions (information requests, confirming studies, project modifications, etc.): 								
	(Attach additional sheets as needed)								
	do not concur with the above certification, therebe a recipient of State funding or a subrecipient of Fo State Smart Growth Public Infrastructure Policy A	ederal funding in accordance with the							
2.	. NOW THEREFORE, pursuant to ECL Article 6, this project is compliant with the New York State Smart Growth Public Infrastructure Policy Act, to the extent practicable, as described in the attached Smart Growth Impact Statement.								
	NYSDOT Commissioner, Regional Director, MO Program Director, Regional Planning & Programming Manager (or official designee):								
Si	Signature	Date							
Ti	Title I	Printed Name							

Michael Sassi, P.E. Ref: 29011.00 January 8, 2015



Attachment B: Culvert Inspection



To: Michael Dignacco Date: January 13, 2015 Memorandum

Project #: 29011.00

From: Kevin Powers, P.E. Re: Culvert Inspection - Route 22 Amenia New York

On December 19, 2014, VHB performed a condition assessment inspection of a 3-sided culvert structure (BIN C824024) which carries New York Route 22 over Amenia Stream in the town of Amenia. The purpose of the inspection was to measure and record primary dimensions of the structure, document the condition of the structure, and identify any structural deficiencies. The structure was last inspected by NYSDOT on October 24, 2013 and received a condition rating of 5.29 on a scale of seven (7), with seven being new or like new construction.

Observations

New York Route 22 over Amenia Stream carries two travel lanes, striped 11' (southbound) and 12' (northbound) with a 5' shoulder on each side. The overall structure length is 41'-0" from fascia to fascia (Figure 1, Photo 1, and Photo 2). The structure has box beam guide railing which continues off the structure for an unspecified distance. The 3-sided culvert structure has a clear opening 14'-0"+/- and an average clear height to the stream bed of 9'-5" on the west face (Figure 2, Photo 8) and 10'-3½" on the east face (Figure 3, Photo 11). The top slab measured 21"+/- with a 3" chamfer at the interface with the vertical legs. The wingwall lengths vary in length and have a nominal thickness of 18".

Northwest Wingwall

The northwest wingwall (Photo 9) is 12'-6" in length and has an exposed height ranging from 10'-9" to 0'-6" at the free end (Figure 2). The overall condition is fair with spalling along the top edge of the wall and at the joint interface with the culvert.

Southwest Wingwall

The southwest wingwall (Photo 10) is 9'-3" in length and has an exposed height ranging from 10'-7" to 3'-11" at the free end (Figure 2). The overall condition is fair with spalling along the top edge of the wall and at the free end. The wall also exhibited scaling of the concrete on the upper half of the exposed face and some efflorescence at the interface with the culvert.

Northeast Wingwall

The northeast wingwall (Photo 12) is 11'-3" in length and has an exposed height ranging from 11'-10" to 4'-5" at the free end (Figure 3). The overall condition is fair with spalling along half of the top edge of the wall.

Southeast Wingwall

The southeast wingwall (Photo 13) is 13'-3" in length and has an exposed height ranging from 12'-3" to 3'-4" at the free end (Figure 3). The overall condition is fair with spalling along the top edge of the wall.

Culvert Vertical Legs





Ref: Culvert Inspection - Route 22 Amenia New York January 13, 2015 Page 2


The vertical legs of the culvert are in good condition, however vertical hairline cracks were observed on each leg. Along the north leg (Photo 16 and Photo 17) the hairline cracks were measured at 9'-5", 17'-3", 24'-10" and 31'-10" from the west end of the culvert. Along the south leg (Photo 18 and Photo 19) hairline cracks were measured at 11'-6", 18'-3", and 28-'8" from the west end of the culvert. The concrete was sounded along each crack and was determined to be solid and in good condition.

Culvert Top Slab

The fascias of the culvert top slab are in poor condition (Photo 14, west side, Photo 15, east side) with significant spalling and exposed rebar along the entire fascia length. The remainder of the culvert top slab under the roadway (Photo 20 and Photo 21) is in good condition.

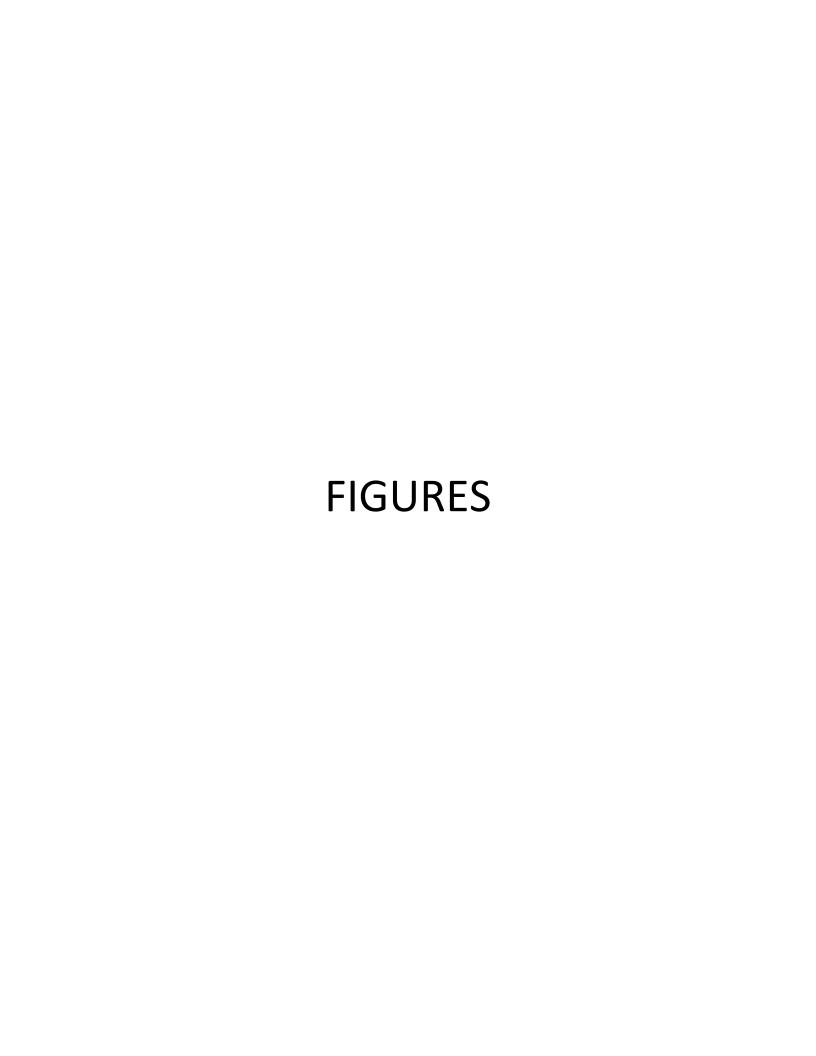

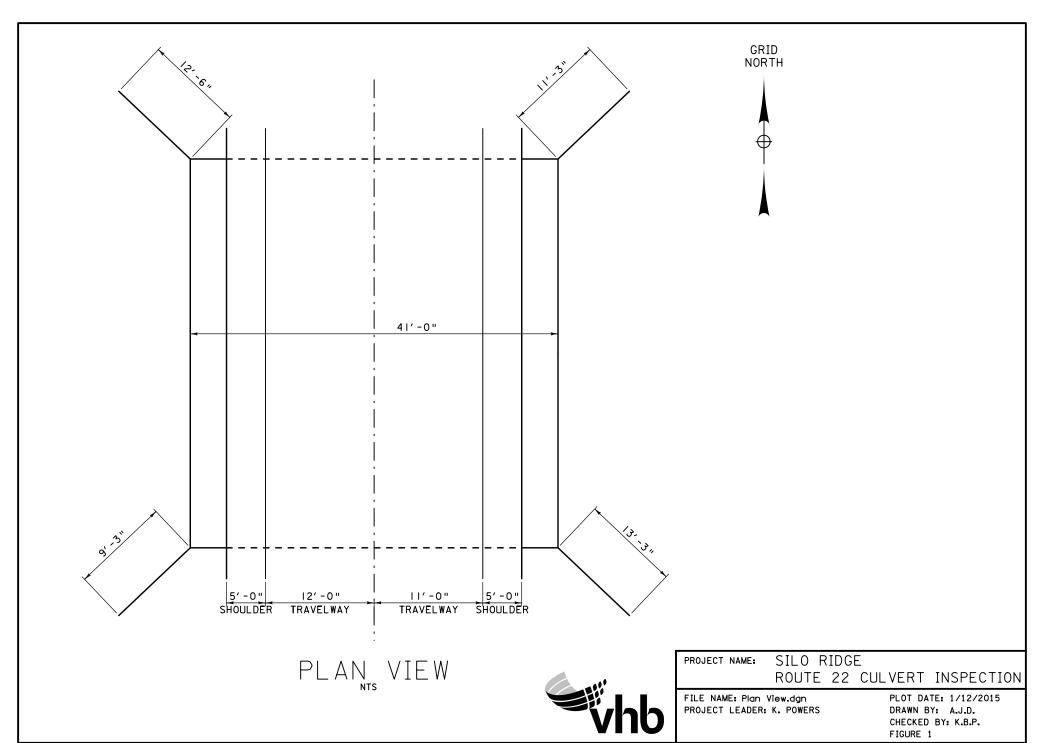

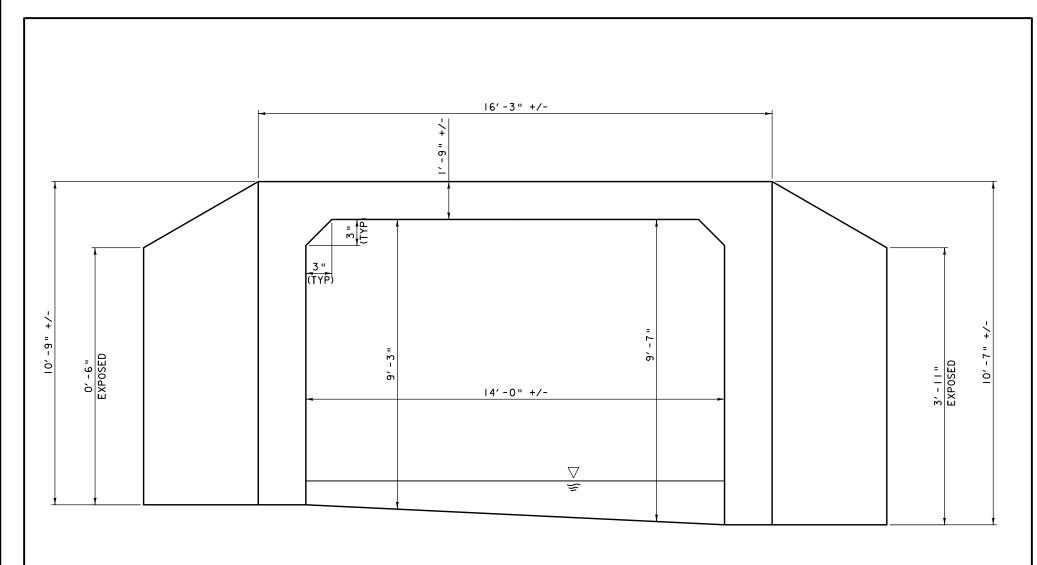


WEST FACE ELEVATION (NTS)



PROJECT NAME: SILO RIDGE
PROJECT NUMBER: ROUTE 22 CULVERT INSPECTION

FILE NAME: West Fascia Culvert ElevationPLVQ&vQddft: 1/13/2015
PROJECT LEADER: K. POWERS DRAWN BY: A.J.D. DRAWN BY: A.J.D. CHECKED BY: K.B.P. FIGURE 2

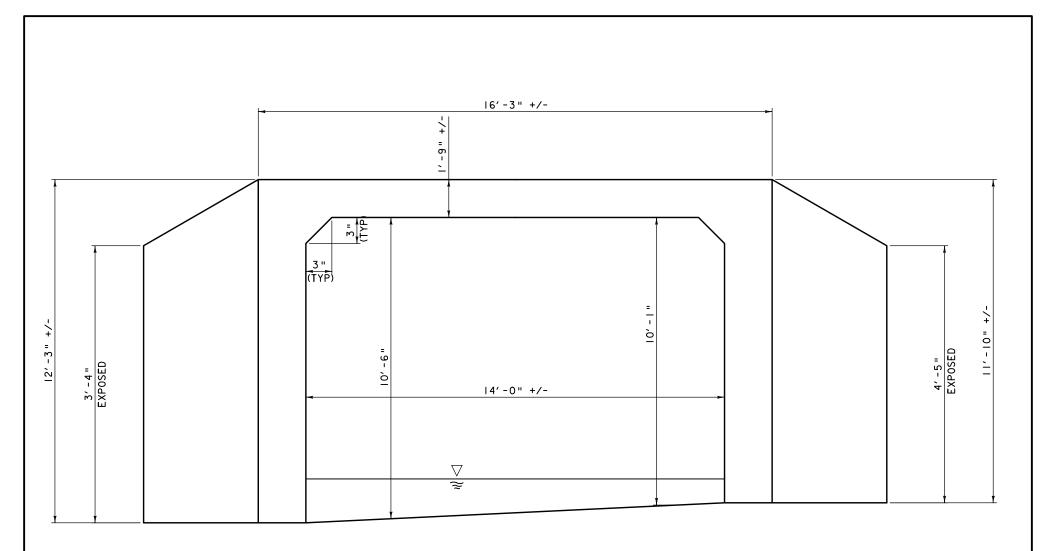

EAST FACE ELEVATION (NTS)



PROJECT NAME: SILO RIDGE
PROJECT NUMBER: ROUTE 22 CULVERT INSPECTION

FILE NAME: East Fascia Culvert ElevationPLW&wDddfic: \$date\$
PROJECT LEADER: K. POWERS DRAWN BY: A.J.D. DRAWN BY: A.J.D. CHECKED BY: K.B.P.

FIGURE 3

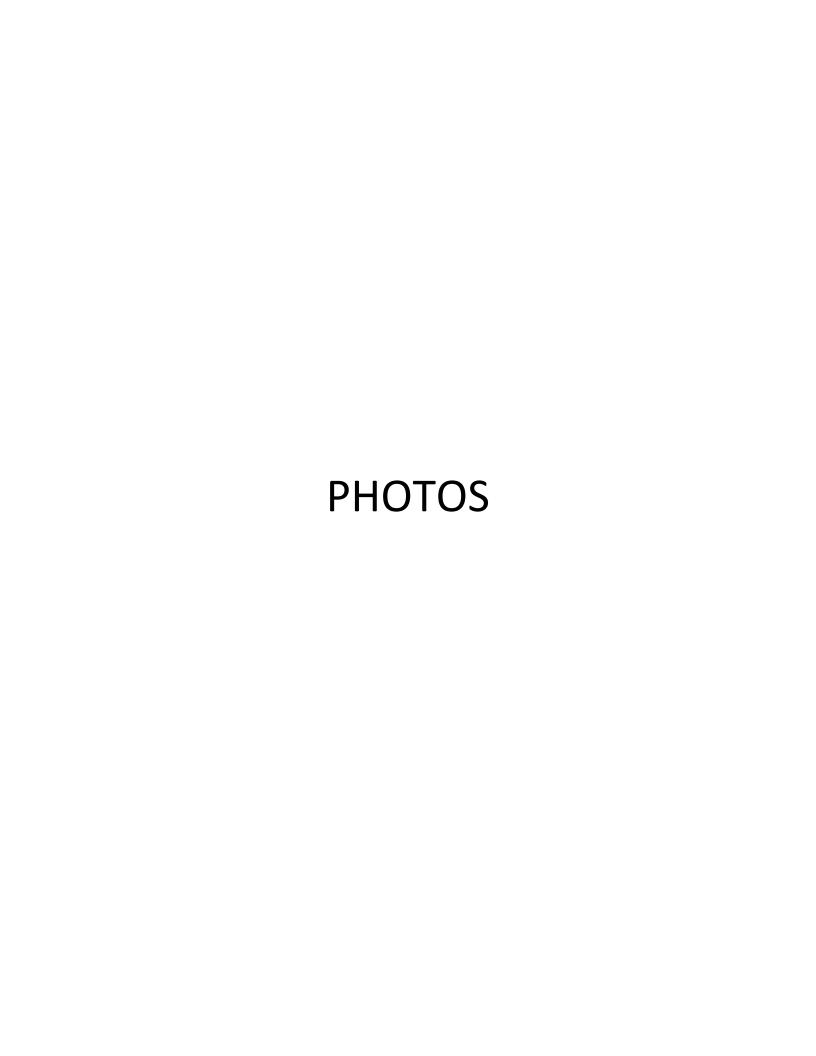


PHOTO INDEX

Photo Log	B-1
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PHOTO 2: Route 22 (looking south)	B-2
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PHOTO 4: Downstream (looking east)	B-3
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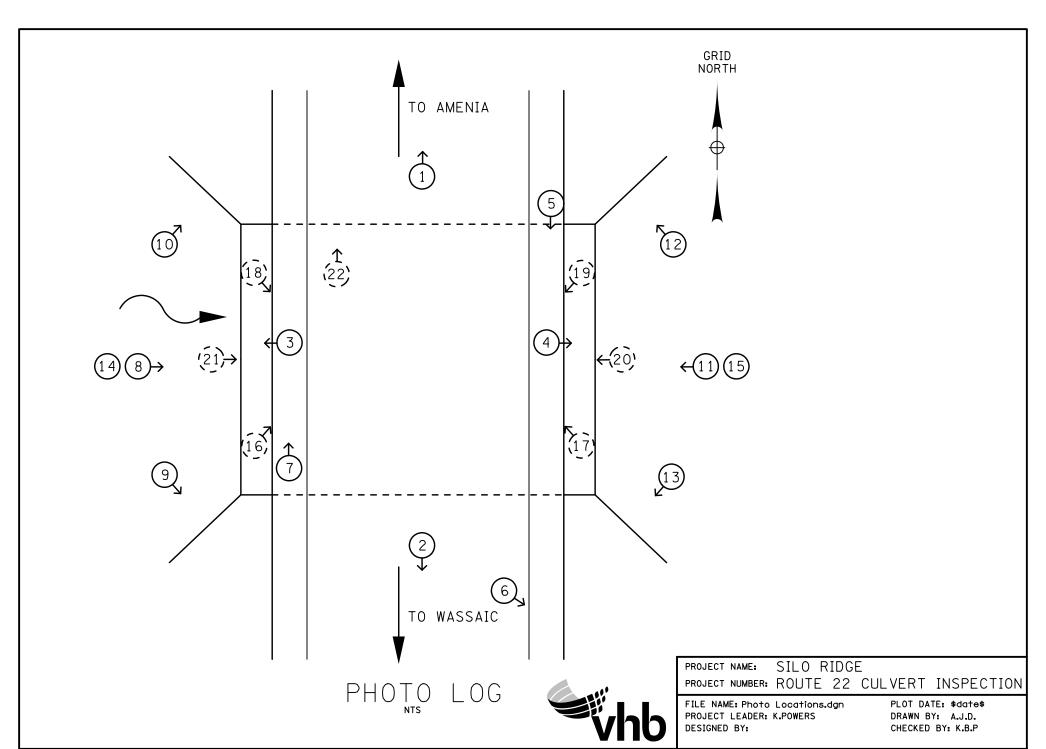




Photo 1: Route 22 (looking north)



Photo 2: Route 22 (looking south)



Photo 3: Upstream (looking west)



Photo 4: Downstream (looking east)



Photo 5: East Bridge Rail (looking south)



Photo 6: East Bridge Rail, Minor Damage



Photo 7: West Bridge Rail (looking north)



Photo 8: Box Culvert – West Fascia



Photo 9: Northwest Wingwall



Photo 10: Southwest Wingwall



Photo 11: Box Culvert – East Fascia



Photo 12: Northeast Wingwall



Photo 13: Southeast Wingwall



Photo 14: Exposed Rebar, West Fascia Top Slab



Photo 15: Exposed Rebar, East Fascia Top Slab



Photo 16: North Leg (looking east)



Photo 17: North Leg (looking west)



Photo 18: South Leg (looking east)



Photo 19: South Leg (looking west)



Photo 20: Top Slab (looking west)



Photo 21: Top Slab (looking east)



Photo 22: Hairline Crack, typical

NYSDOT Ref No. AW 08.05.701; SEQR # 07-0192

Date Issued: 7/31/2014

Latest Issue (1/8/2015 \(\frac{1}{2} \)

Number	Drawing Title	Latest Issue
GP-0	Overall Key Plan	1/8/2015
GP-1	General Plan 1	\ 1/8/2015
GP-2	General Plan 2	(1/8/2015)
GP-3	General Plan 3	\(\) 1/8/2015 \(\)
GP-4A	General Plan 4 - Phase 1	\ \ 1/8/2015 \
↑ GP-4B	General Plan 4 - MDP	1/8/2015
GP-5A	General Plan 5 - Option 1	\ 1/8/2015
GP-5B	General Plan 5 - Option 2	(1/8/2015)
GP-6	General Plan 6	(1/8/2015)
WZ-1	Work Zone Traffic Control Plan - 1	7/31/2014
WZ-2	Work Zone Traffic Control Plan - 2	7/31/2014
WZ-3	Work Zone Traffic Control Plan - 3	7/31/2014
MD-1	Miscellaneous Details 1	1/8/2015
MD-2	Miscellaneous Details 2	7/31/2014
MD-3	Miscellaneous Details 3	1/8/2015
SD-1	Sight Distance Triangles 1	1/8/2015
SD-2	Sight Distance Triangles 2	1/8/2015

ROADWAY IMPROVEMENT PLANS US ROUTE 44 AND NYS ROUTE 22

AT SILO RIDGE BETWEEN REFERENCE MARKERS AMENIA, NEW YORK

General Notes:

<u>REFERENCES</u>

- 1. SPECIFICATIONS: "NEW YORK STATE DEPARTMENT OF TRANSPORTATION (NYSDOT) CONSTRUCTION AND MATERIALS", OFFICE OF ENGINEERING,
- 2. "NEW YORK STATE DEPARTMENT OF TRANSPORTATION HIGHWAY DESIGN MANUAL" VOLUMES I & II, LATEST EDITION.
- 3. "AMERICAN ASSOCIATION OF STATE HIGHWAY AND TRANSPORTATION OFFICIALS (AASHTO) POLICY ON GEOMETRIC DESIGN OF HIGHWAYS AND STREETS", 2011.
- 4. NATIONAL MUTCD (2009) EDITION AND THE NEW YORK STATE
- 5. AMERICANS WITH DISABILITIES ACT ACCESSIBILITY GUIDELINES FOR BUILDINGS AND FACILITIES (ADAAG), LATEST EDITION.


GENERAL

- 6. THE LOCAL FIRE DEPARTMENTS, EMERGENCY SQUADS, AND THE LOCAL POLICE DEPARTMENT SHALL BE NOTIFIED A MINIMUM OF FIVE (5) WORKING DAYS PRIOR TO THE CONTRACTOR COMMENCING CONSTRUCTION. THE ABOVE LISTED AGENCIES OR DEPARTMENTS SHALL BE NOTIFIED A MINIMUM OF ONE (1) WORKING DAY IN ADVANCE OF THE CONTRACTOR CONDUCTING WORK THAT WILL HAVE AN IMPACT ON THE TRAVEL ROUTES OR RESPONSE ROUTES.
- 7. ALL NECESSARY PERMITS SHALL BE OBTAINED PRIOR TO THE COMMENCEMENT OF WORK
- 8. ALL WORK WITHIN THE N.Y.S. RIGHT-OF-WAY (ROW), AS SHOWN ON THE PLANS, SHALL CONFORM TO THE NYSDOT STANDARD SPECIFICATION, STANDARD DETAILS, AND PERMITS, OR AS ORDERED BY THE NYSDOT REPRESENTATIVE.
- 9. THE CONTRACTOR'S ATTENTION IS DIRECTED TO THE FACT THAT, DUE TO THE NATURE OF RECONSTRUCTION PROJECTS, THE EXACT EXTENT OF RECONSTRUCTION WORK CANNOT ALWAYS BE ACCURATELY DETERMINED PRIOR TO THE COMMENCEMENT OF WORK. THESE CONTRACT DOCUMENTS HAVE BEEN PREPARED BASED ON FIELD INSPECTION AND OTHER INFORMATION AVAILABLE AT THE TIME. ACTUAL FIELD CONDITIONS MAY REQUIRE THE CONTRACTOR TO PERFORM WORK IN ACCORDANCE WITH FIELD CONDITIONS.
- 10. THE CONTRACTOR SHALL VISIT THE PROJECT SITE BEFORE BIDDING TO BECOME FAMILIAR WITH PRESENT CONDITIONS AND TO JUDGE FOR THEMSELVES THE EXTENT AND NATURE OF WORK TO BE DONE UNDER THIS CONTRACT.
- 11. THE CONTRACTOR SHALL TAKE PRECAUTIONS NOT TO LEAVE DEBRIS, MATERIALS AND TOOLS, ETC. ON THE ROADWAY SURFACE WHEN LEAVING THE WORK AREA. IN ADDITION, THE CONTRACTOR SHALL TAKE PRECAUTIONS THAT NO DEBRIS, ETC., INTERFERES WITH ADJACENT OPEN TRAFFIC LANES AND PEDESTRIAN WALKS.
- 12. THE CONTRACTOR SHALL BE RESPONSIBLE FOR ALL COSTS, FEES AND PERMITS TO COMPLETE THE WORK.
- 13. REMOVE, RESTORE OR REPLACE ALL EXISTING SIGNS AS ORDERED BY
- 14. ALL WORK AT SITE ACCESS POINTS SHALL BE COORDINATED WITH THE APPROVED SITE PLAN.
- 15. THE CONTRACTOR SHALL CLEAN ALL EXISTING CATCH BASINS ALONG AND IMMEDIATELY ADJACENT TO ROUTE 22 AND ROUTE 44 SITE FRONTAGE AT THE COMPLETION OF CONSTRUCTION AS DIRECTED BY THE STATE ENGINEER.

16. THE CONTRACTOR SHALL REPAIR THE EXISTING SHOULDER, SIDEWALK AND CURBING WITHIN THE PROJECT LIMITS, AS ORDERED BY THE STATE ENGINEER.

- DAYS BEFORE THE CONTRACTOR COMMENCES WORK. ANY UTILITY RELOCATIONS OR CROSSINGS SHALL BE COORDINATED WITH THE UTILITY COMPANY OWNING THE FACILITY
- 18. EXISTING UTILITY FACILITIES REMOVAL, RELOCATION OR MODIFICATION SHALL BE COMPLETED PRIOR TO COMMENCING PAVEMENT WORK. CONTRACTOR IS RESPONSIBLE FOR THE COORDINATION OF THE MODIFICATION OF ALL UTILITIES.

- 19. THE CONTRACTOR IS TO EMPLOY A LICENSED SURVEYOR TO PERFORM ANY REQUIRED LAYOUT, ESTABLISHMENT OF ELEVATIONS AND GRADES, PRIOR TO CONSTRUCTION. ALL LAYOUT OF PROPOSED WORK SHALL BE DONE IN CONFORMANCE WITH ITEM 625.01 - SURVEY AND STAKEOUT.
- 20. THE CONTRACTOR SHALL TAKE ALL PRECAUTIONS NOT TO DISTURB ANY MONUMENTS AND BENCH MARKS WITHIN PROJECT LIMITS PRIOR TO THE START OF ANY EXCAVATION.
- 21. ANY EXPENSE INCURRED IN REPLACING MONUMENTS OR BENCHMARKS THAT THE CONTRACTOR, OR ANY EMPLOYEE, MAY HAVE FAILED TO PRESERVE SHALL BE CHARGED TO THE CONTRACTOR FROM THE AMOUNT TO BE PAID FOR DOING THE WORK UNDER THIS CONTRACT.

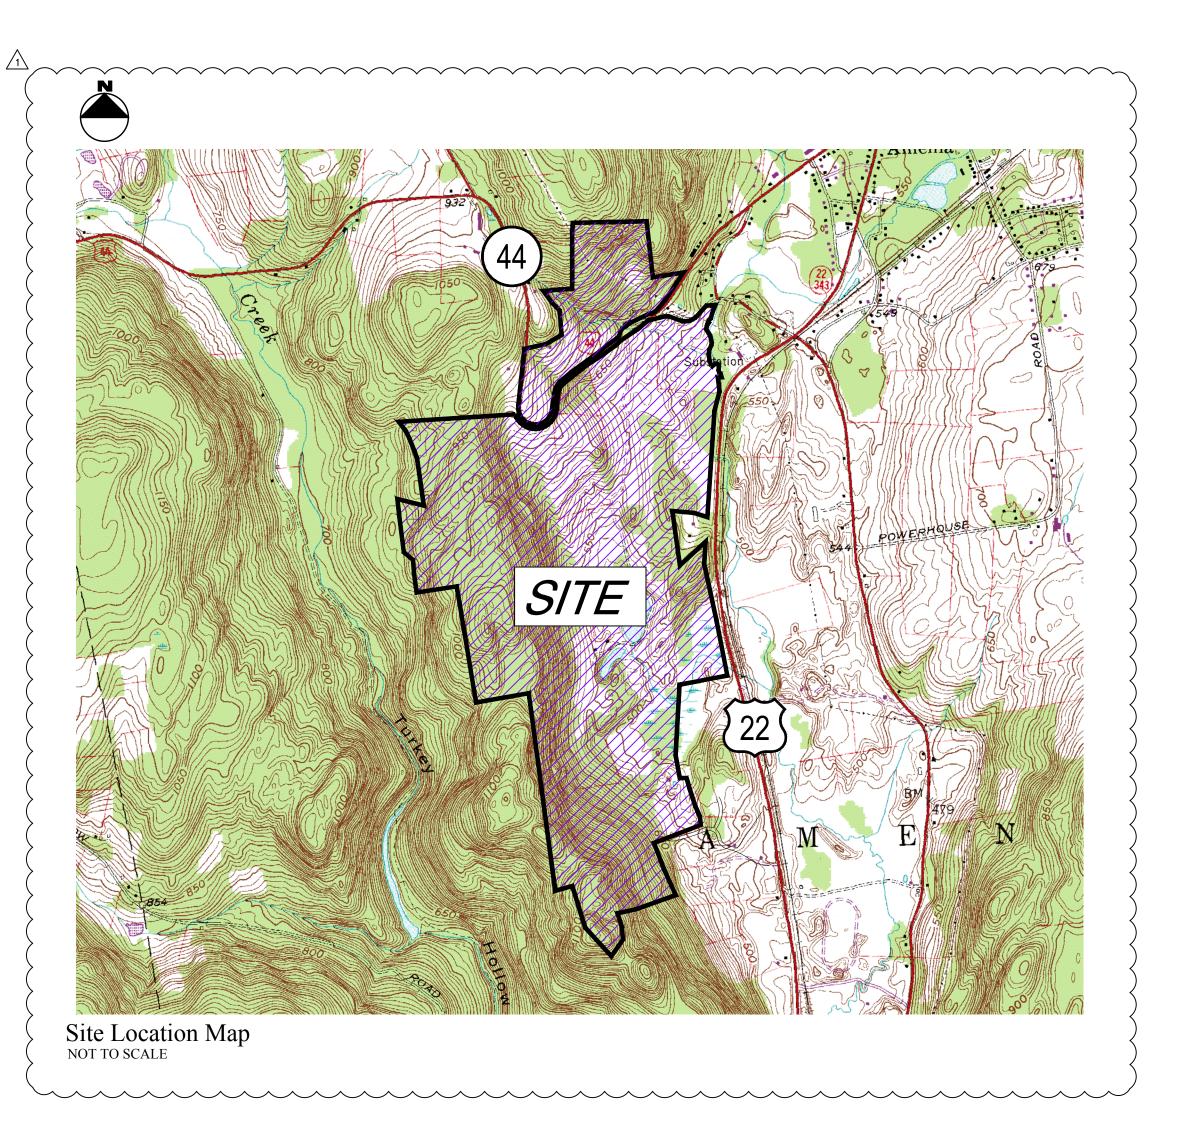

SPECIFICATIONS NOTE: NYSDOT ITEMS INDICATED WITHIN THE PLANS ARE FROM THE LATEST EDITION OF THE SPECIFICATIONS, AND ARE REFERENCED FOR MATERIALS AND METHODS OF CONSTRUCTION.

REFERENCE DRAWINGS:

SILO RIDGE RESORT COMMUNITY PHASE 1 SITE PLANS C2.00 - OVERALL EXISTING CONDITIONS PLAN

C4.00 - OVERALL SITE LAYOUT PLAN

C12.00-OVERALL EROSION AND SEDIMENT CONTROL

C12.02 - EROSION AND SEDIMENT CONTROL PLAN 2

C12.03-EROSION-AND-SEDIMENT-CONTROL-PLAN-3~

C12.09 - EROSION AND SEDIMENT CONTROL PLAN 1 C12.10-OVERALISTEMPORARY SEDIMENT BASIN PLAN

C12.11 - TEMPORARY SEDIMENT BASIN PLAN 1

C12.12 - TEMPORARY SEDIMENT BASIN PLAN 2

C12.13_TEMPORARY_SEDIMENT_BASIN_PLAN-3

C12.14 - TEMPORARY SEDIMENT BASIN PLAN 4

13:02-PLANTING PLANTILE 2 L3.03 - PLANTING PLANTILE 3

L3.10 - PLANTING PLAN TILE 10

L3.13 - PLANTING PLAN ENLARGEMENT

L3.14 - PLANTING PLAN ENLARGEMENT

SILO RIDGE RESORT COMMUNITY MASTER

DEVELOPMENT PLANS

SP-2 - OVERALL SITE PLAN

SP-5 - OVERALL PHASING PLAN

GP-1 - GRADING PLAN 1 GP-2 - GRADING PLAN 2

SW-1 - OVERALL STORMWATER MANAGEMENT

PRACTICE IDENTIFICATION PLAN

U-1 - OVERALL WASTEWATER MASTER PLAN

U-2 - OVERALL WATER SUPPLY SYSTEM MASTER PLAN

NYSDOT REFERENCE STANDARD SHEETS:

209: SOIL EROSION AND SEDIMENT CONTROL

209-01 - LINEAR MEASURES

209-02 - CHECK DAMS

209-03 - DRAINAGE STRUCTURE INLET

PROTECTION

209-04 - PIPE INLET/OUTLET PROTECTION - PIPE

SLOPE DRAIN

209-05 - CONSTRUCTION ENTRANCES

604: DRAINAGE STRUCTURES 604-02 - DRAINAGE STRUCTURE DETAILS

606: GUIDE RAILING

606-04 - BOX BEAM GUIDE RAIL

611: PLANTING

611-01 - LANDSCAPE PLANTING DETAILS

655: FRAMES. GRATES AND COVERS

655-01 - RECTANGULAR GRATES

655-02 - PARALLEL BAR FRAMES AND GRATES

685: PAVEMENT MARKINGS 685-01 - PAVEMENT MARKING DETAILS





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$\overline{1}$	AS PER NYS	рот сомм	ENTS	1/8/2015	A
No.		Revision		Date	Ар
Design	ed by ACD	Drawn by	DAR	Checked by M	W.
	hecked by ME	3	Approved b		
Scale	As Shown		Date July	31, 2014	
Decise.	L Titl.			•	

Silo Ridge Resort Community

4651 Route 22 Amenia, New York

Issued for

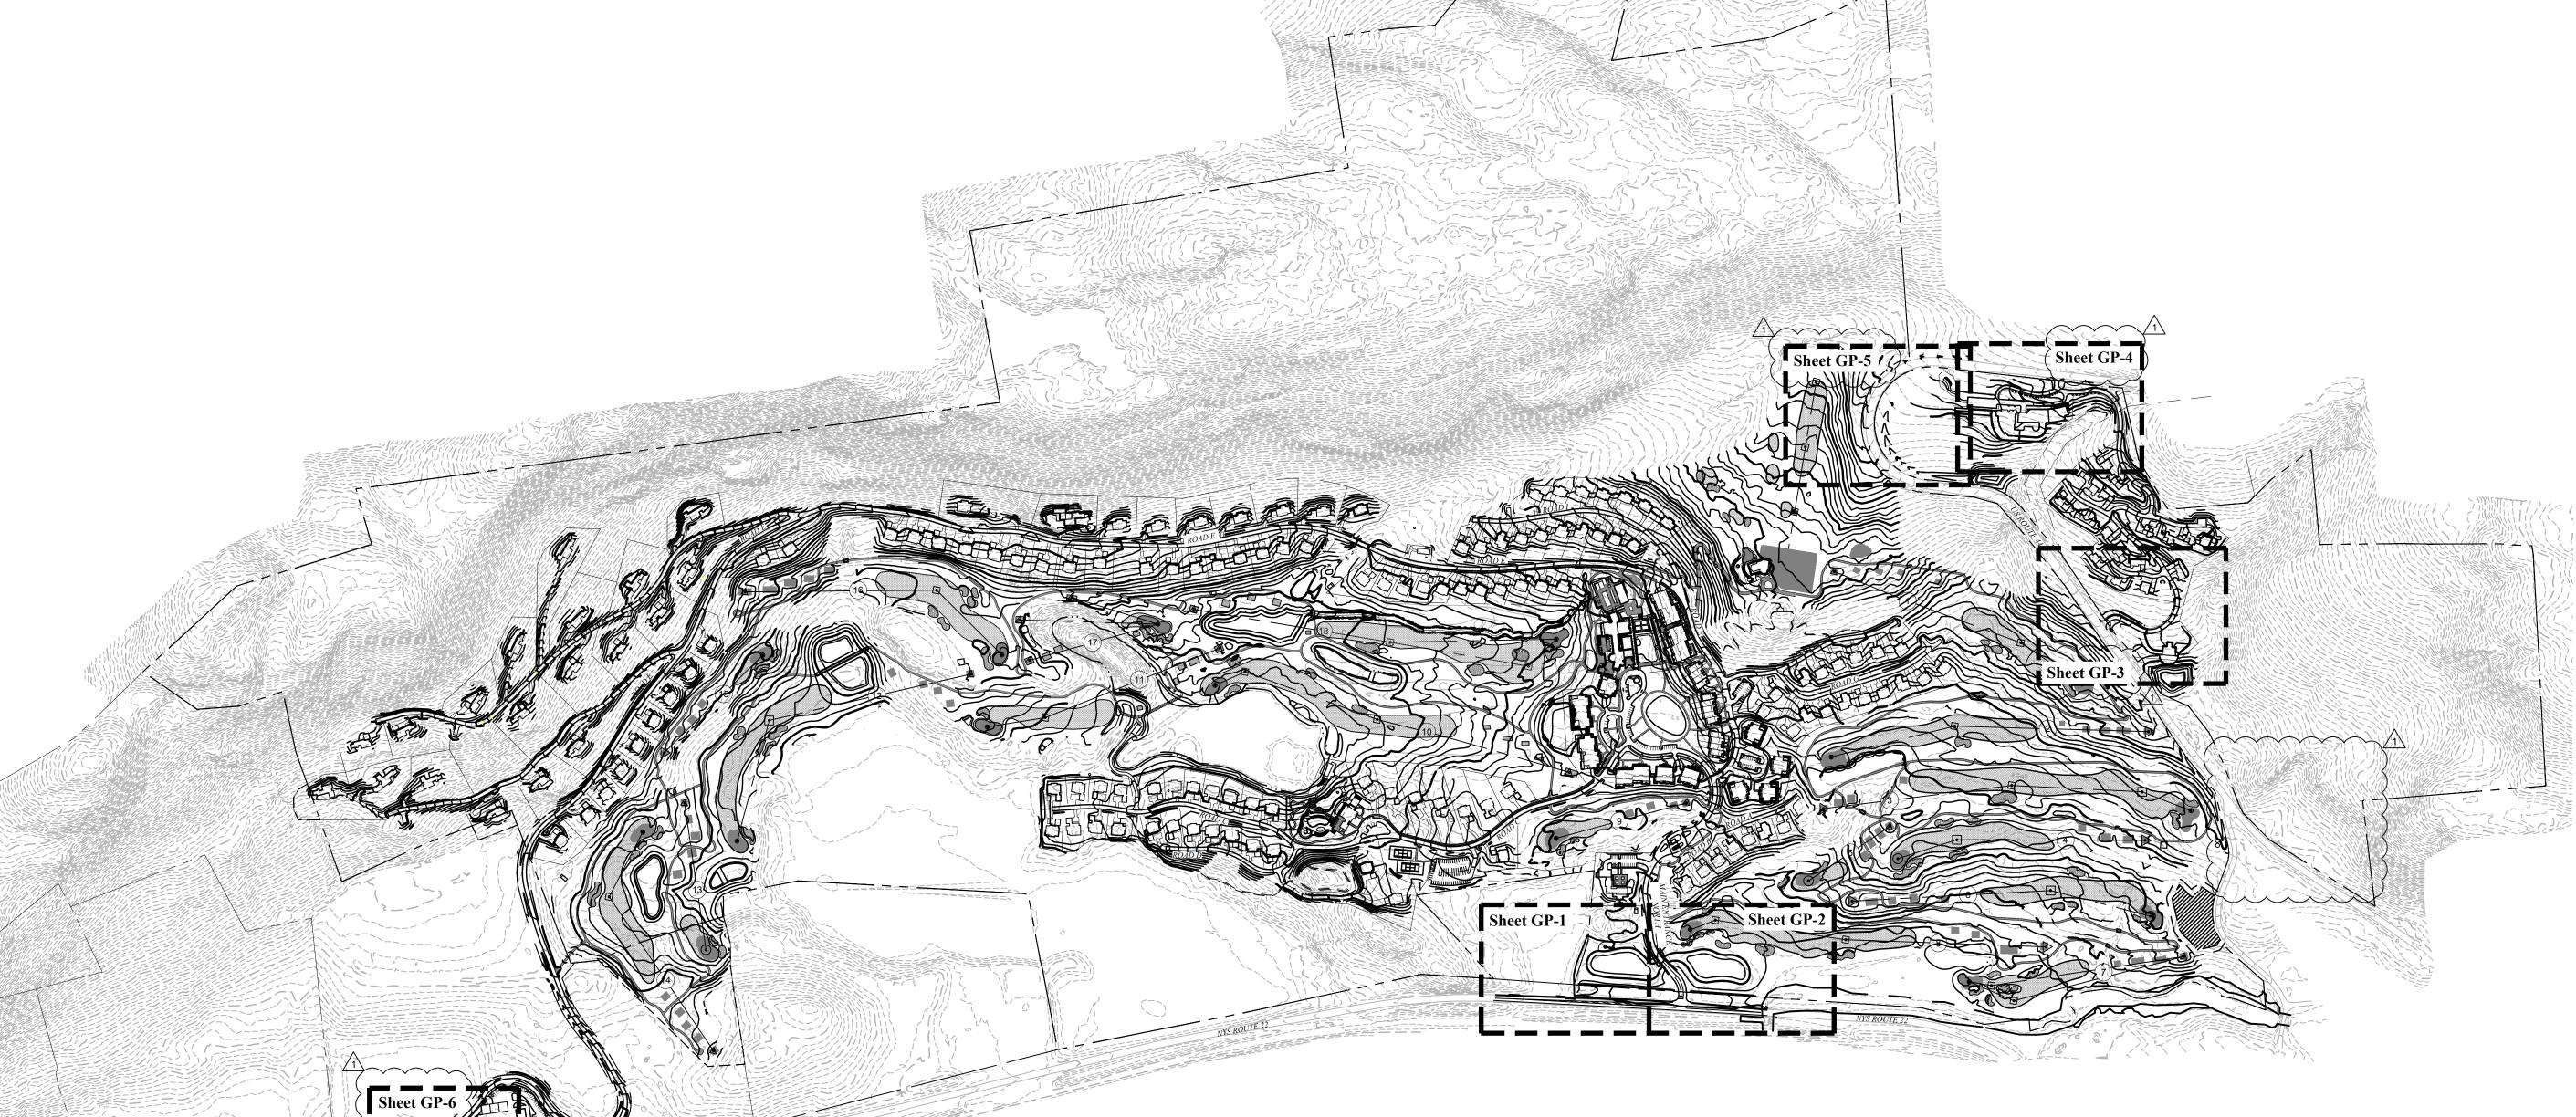NYSDOT Permit

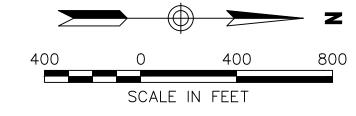Overall Key Plan

Amanda C. DeCesare
N.Y. Professional Engineer
NY Lic. No. 084690

NYS ROUTE 22°

MILL AND RESURFACE
EXISTING PAVEMENT
(MATCH EXISTING
GRADES)

MEET EXISTING PAVEMENT MARKINGS

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AS PER NYSDOT COMMENTS Designed by ACD Drawn by DAR Scale As Shown ate July 31, 2014

Silo Ridge Resort Community

4651 Route 22 Amenia, New York

NYSDOT Permit

Not Approved for Construction

Drawing Title

General Plan 1

Notes:

Amanda C. DeCesare N.Y. Professional Engineer NY Lic. No. 084690

MAIN ENTRANCE - 1

3"-4" SUGAR MAPLES (TYP) TO
BE TRANSPLANTED FROM WITHIN
THE EXISTING SITE TO ALONG

CROSSHATCHING (YELLOW) ITEM #687.0201-

SUPERPAVE HMA ASPHALT PAVEMENT (REFER TO DETAIL ON SHEET MD-1) —

3" SUGAR MAPLES TO BE PLANTED ALONG ROUTE 22

REFER TO SECTION UP-1
ON SHEET MD-3,
MISCELLANEOUS DETAILS 3

SOLID LINE (WHITE)
ITEM #687.0101

1. FOR WORK ZONE TRAFFIC CONTROL REFER TO WORK ZONE TRAFFIC

CONTROL PLAN 1 AND 2.

2. FOR SIGHT DISTANCE TRIANGLES AND MATRICES REFER TO SD-1, SIGHT DISTANCE TRIANGLES 1. FOR CROSS SECTIONS UP-1 AND UP-2 REFER TO MD-3, MISCELLANEOUS DETAILS 3.

STONE STACK WALL OHW

PREFORMED REFLECTIVE
TURN ARROW (WHITE)
(BY OTHERS) ITEM #688.04

UP-2

REFER TO SECTION UP-2 ON SHEET MD-3,

MISCELLANEOUS DETAILS 3-


SAWCUT LIMIT (TYP) ITEM #520.5014


SOLID LINE (YELLOW)

ITEM #687.0201—

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No.		Revision		Date	Α
Design	ed by ACD	Drawn by	DAR	Checked by M	/ W
CAD cl	hecked by <i>ME</i>	3	Approved I	°y ACD	
Scale	As Shown		Date July	y 31, 2014	
Project	t Title				

Silo Ridge Resort Community

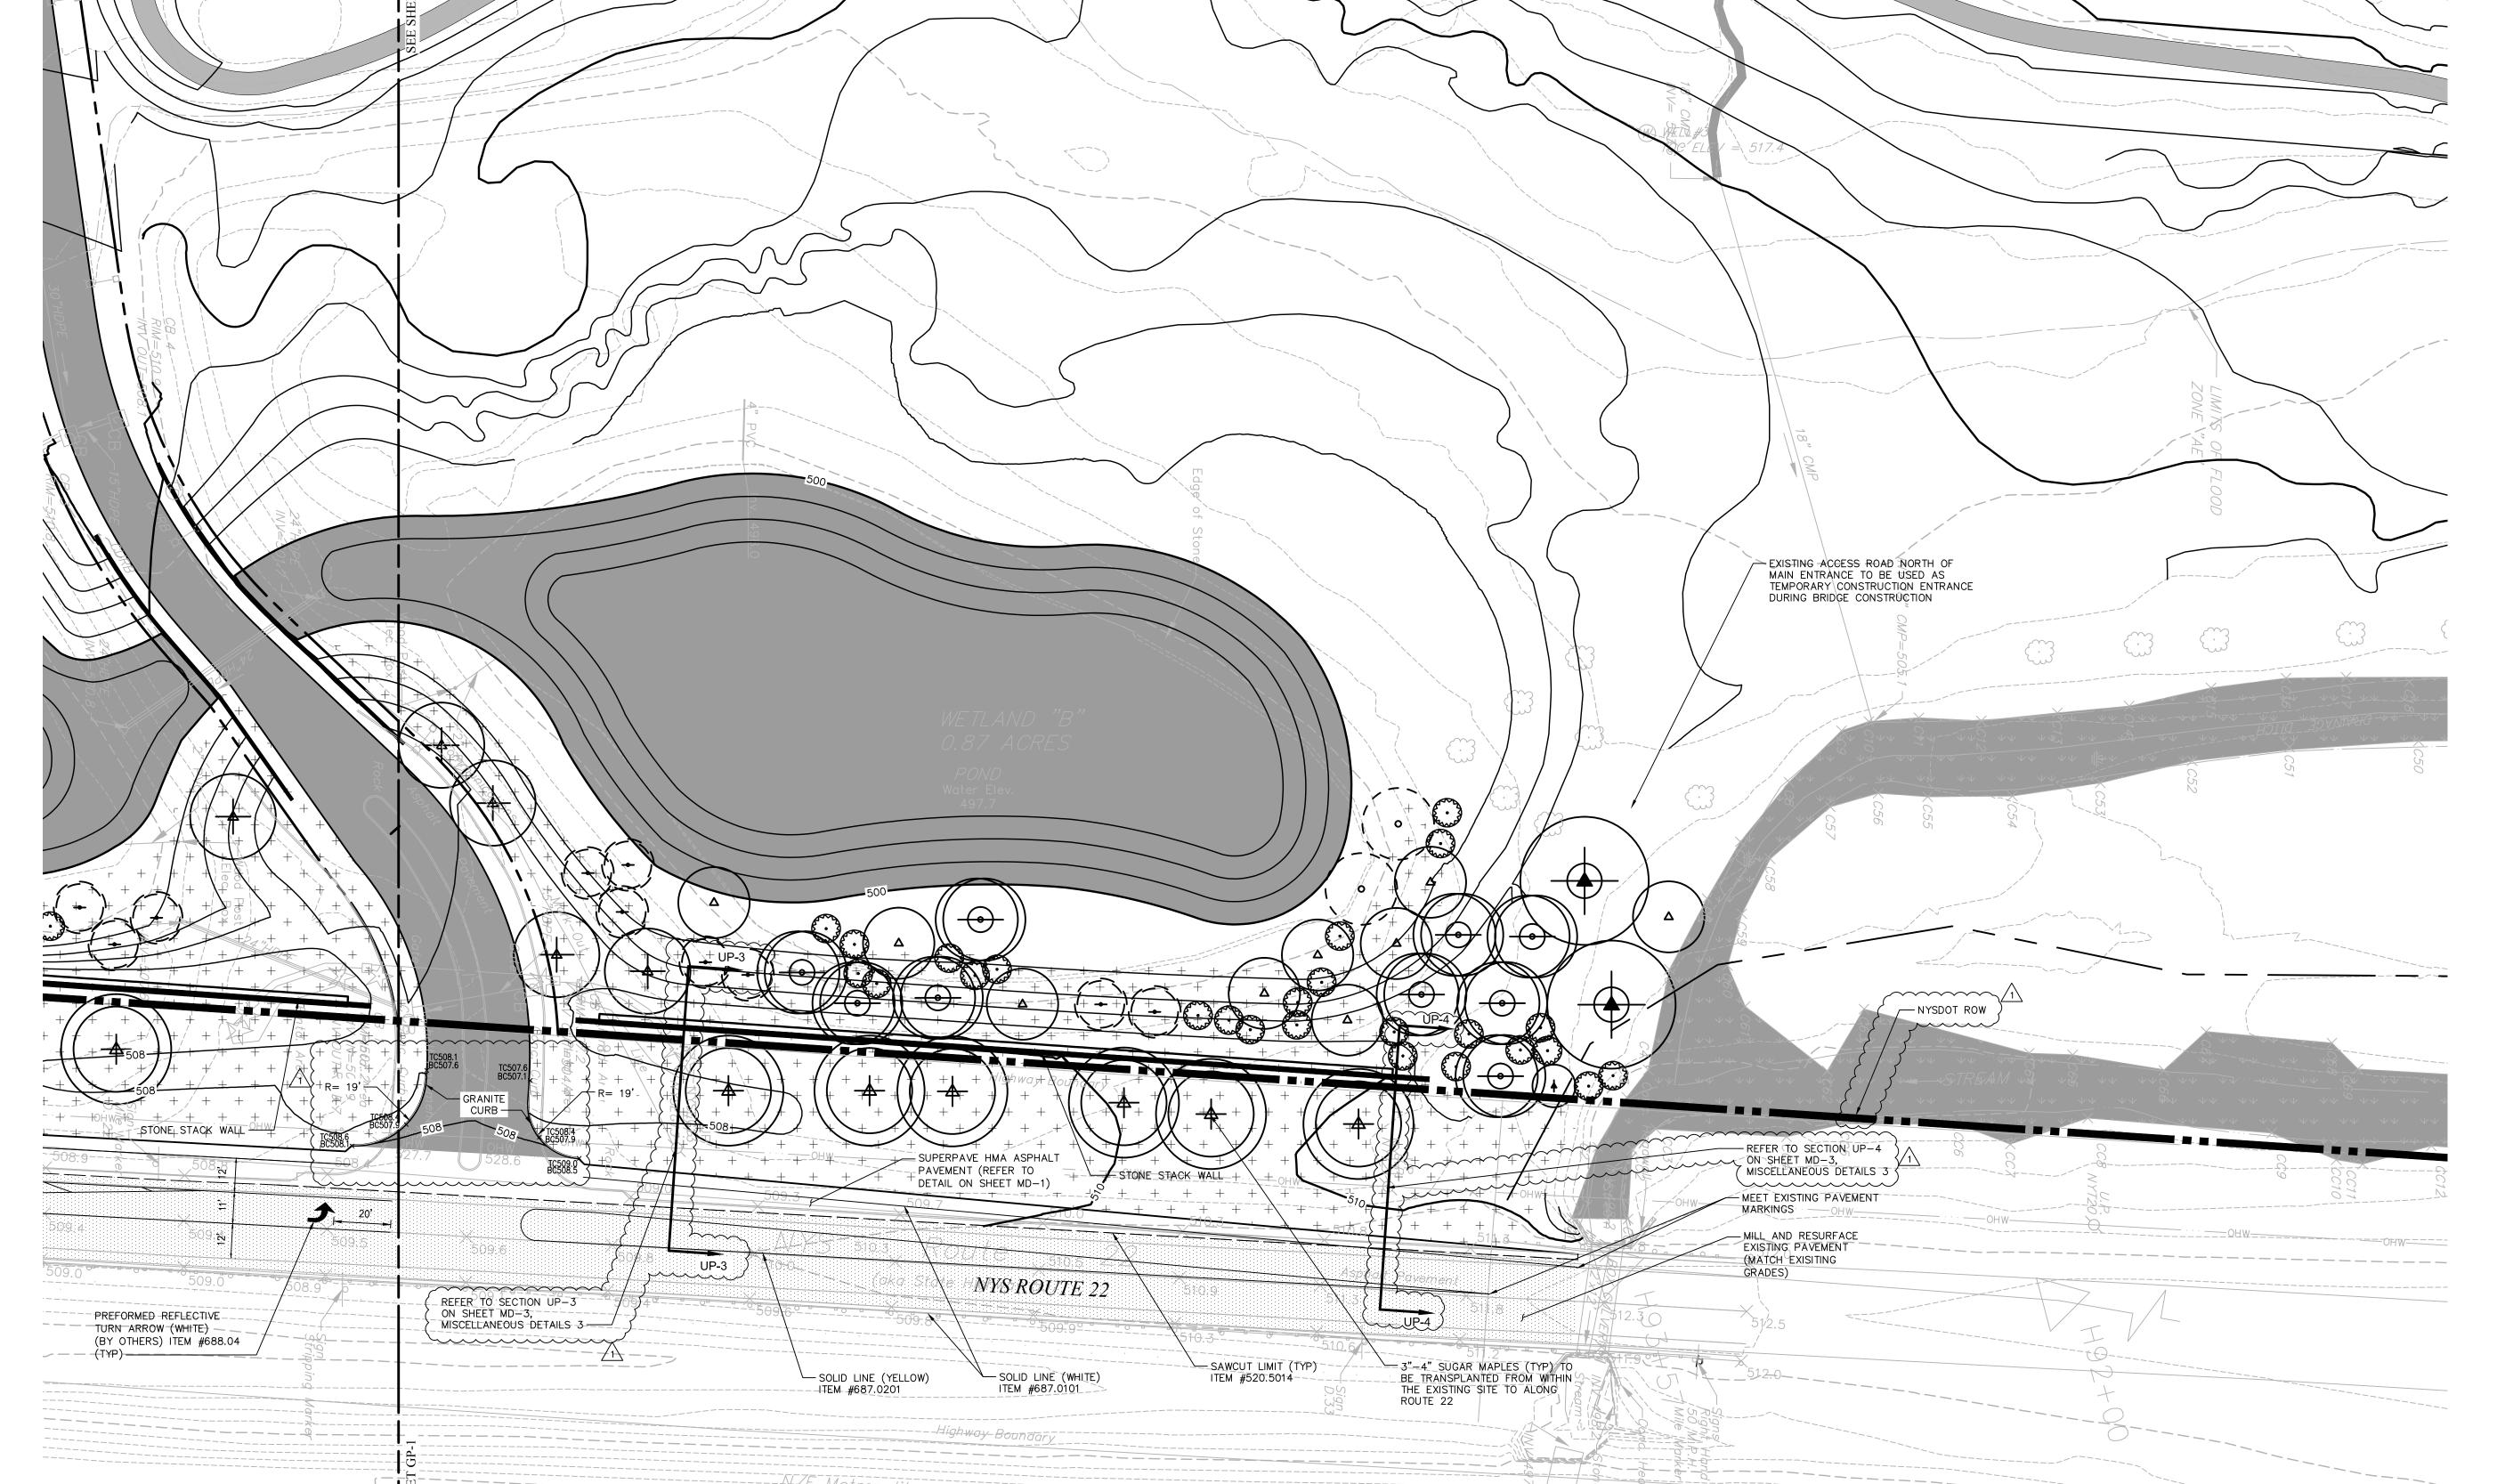4651 Route 22 Amenia, New York

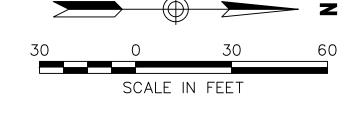NYSDOT Permit

Not Approved for Construction

Drawing Title

General Plan 2

MAIN ENTRANCE - 2

1. FOR WORK ZONE TRAFFIC CONTROL REFER TO WORK ZONE TRAFFIC

CONTROL PLAN 1 AND 2.

2. FOR SIGHT DISTANCE TRIANGLES AND MATRICES REFER TO SD-1,
SIGHT DISTANCE TRIANGLES 1.

3. FOR CROSS SECTIONS UP-3 AND UP-4 REFER TO MD-3,
MISCELLANEOUS DETAILS 3.

Amanda C. DeCesare

N.Y. Professional Engineer

NY Lic. No. 084690

VINEYARD COTTAGES ENTRANCE




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30 0 30 60 SCALE IN FEET



Silo Ridge Resort Community

4651 Route 22 Amenia, New York

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Drawing Title

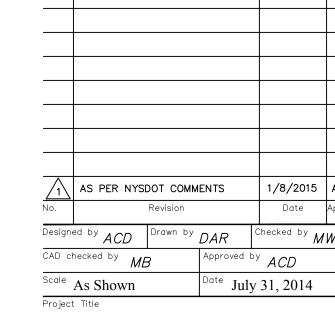General Plan 3

GP 3

Sheet 5 of 18 1

Amanda C. DeCesare
N.Y. Professional Engineer
NY Lic. No. 084690

1. FOR WORK ZONE TRAFFIC CONTROL REFER TO WORK ZONE TRAFFIC CONTROL PLAN 3.

2. A USE AND OCCUPANCY PERMIT IS REQUIRED FOR THE UTILITIES WITHIN THE NYSDOT RIGHT OF WAY (REFER TO DETAIL ON SHEET MD-2).

3. THE ENTRANCE SHALL BE GATED FOR EMERGENCY ACCESS ONLY.

4. FOR SIGHT DISTANCE TRIANGLES AND MATRICES REFER TO SD-2, SIGHT DISTANCE TRIANGLES 2.

SCALE IN FEET

AS PER NYSDOT COMMENTS

Designed by ACD Drawn by DAR

Resort Community

Scale As Shown

Silo Ridge


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WINERY ENTRANCE

Notes:

1. ACCESS TO OVERLOOK TO BE BUILT DURING PHASE 1 AS SHOWN.
DETAILED PLANS FOR ACCESS TO FUTURE WINERY AND VINEYARD
COTTAGES TO BE PROVIDED DURING SITE PLAN PHASE 2.
2. FOR SIGHT DISTANCE TRIANGLES AND MATRICES REFER TO SHEET
SD-2, SIGHT DISTANCE TRIANGLES 2.

Not Approved for Construction

Drawing Title

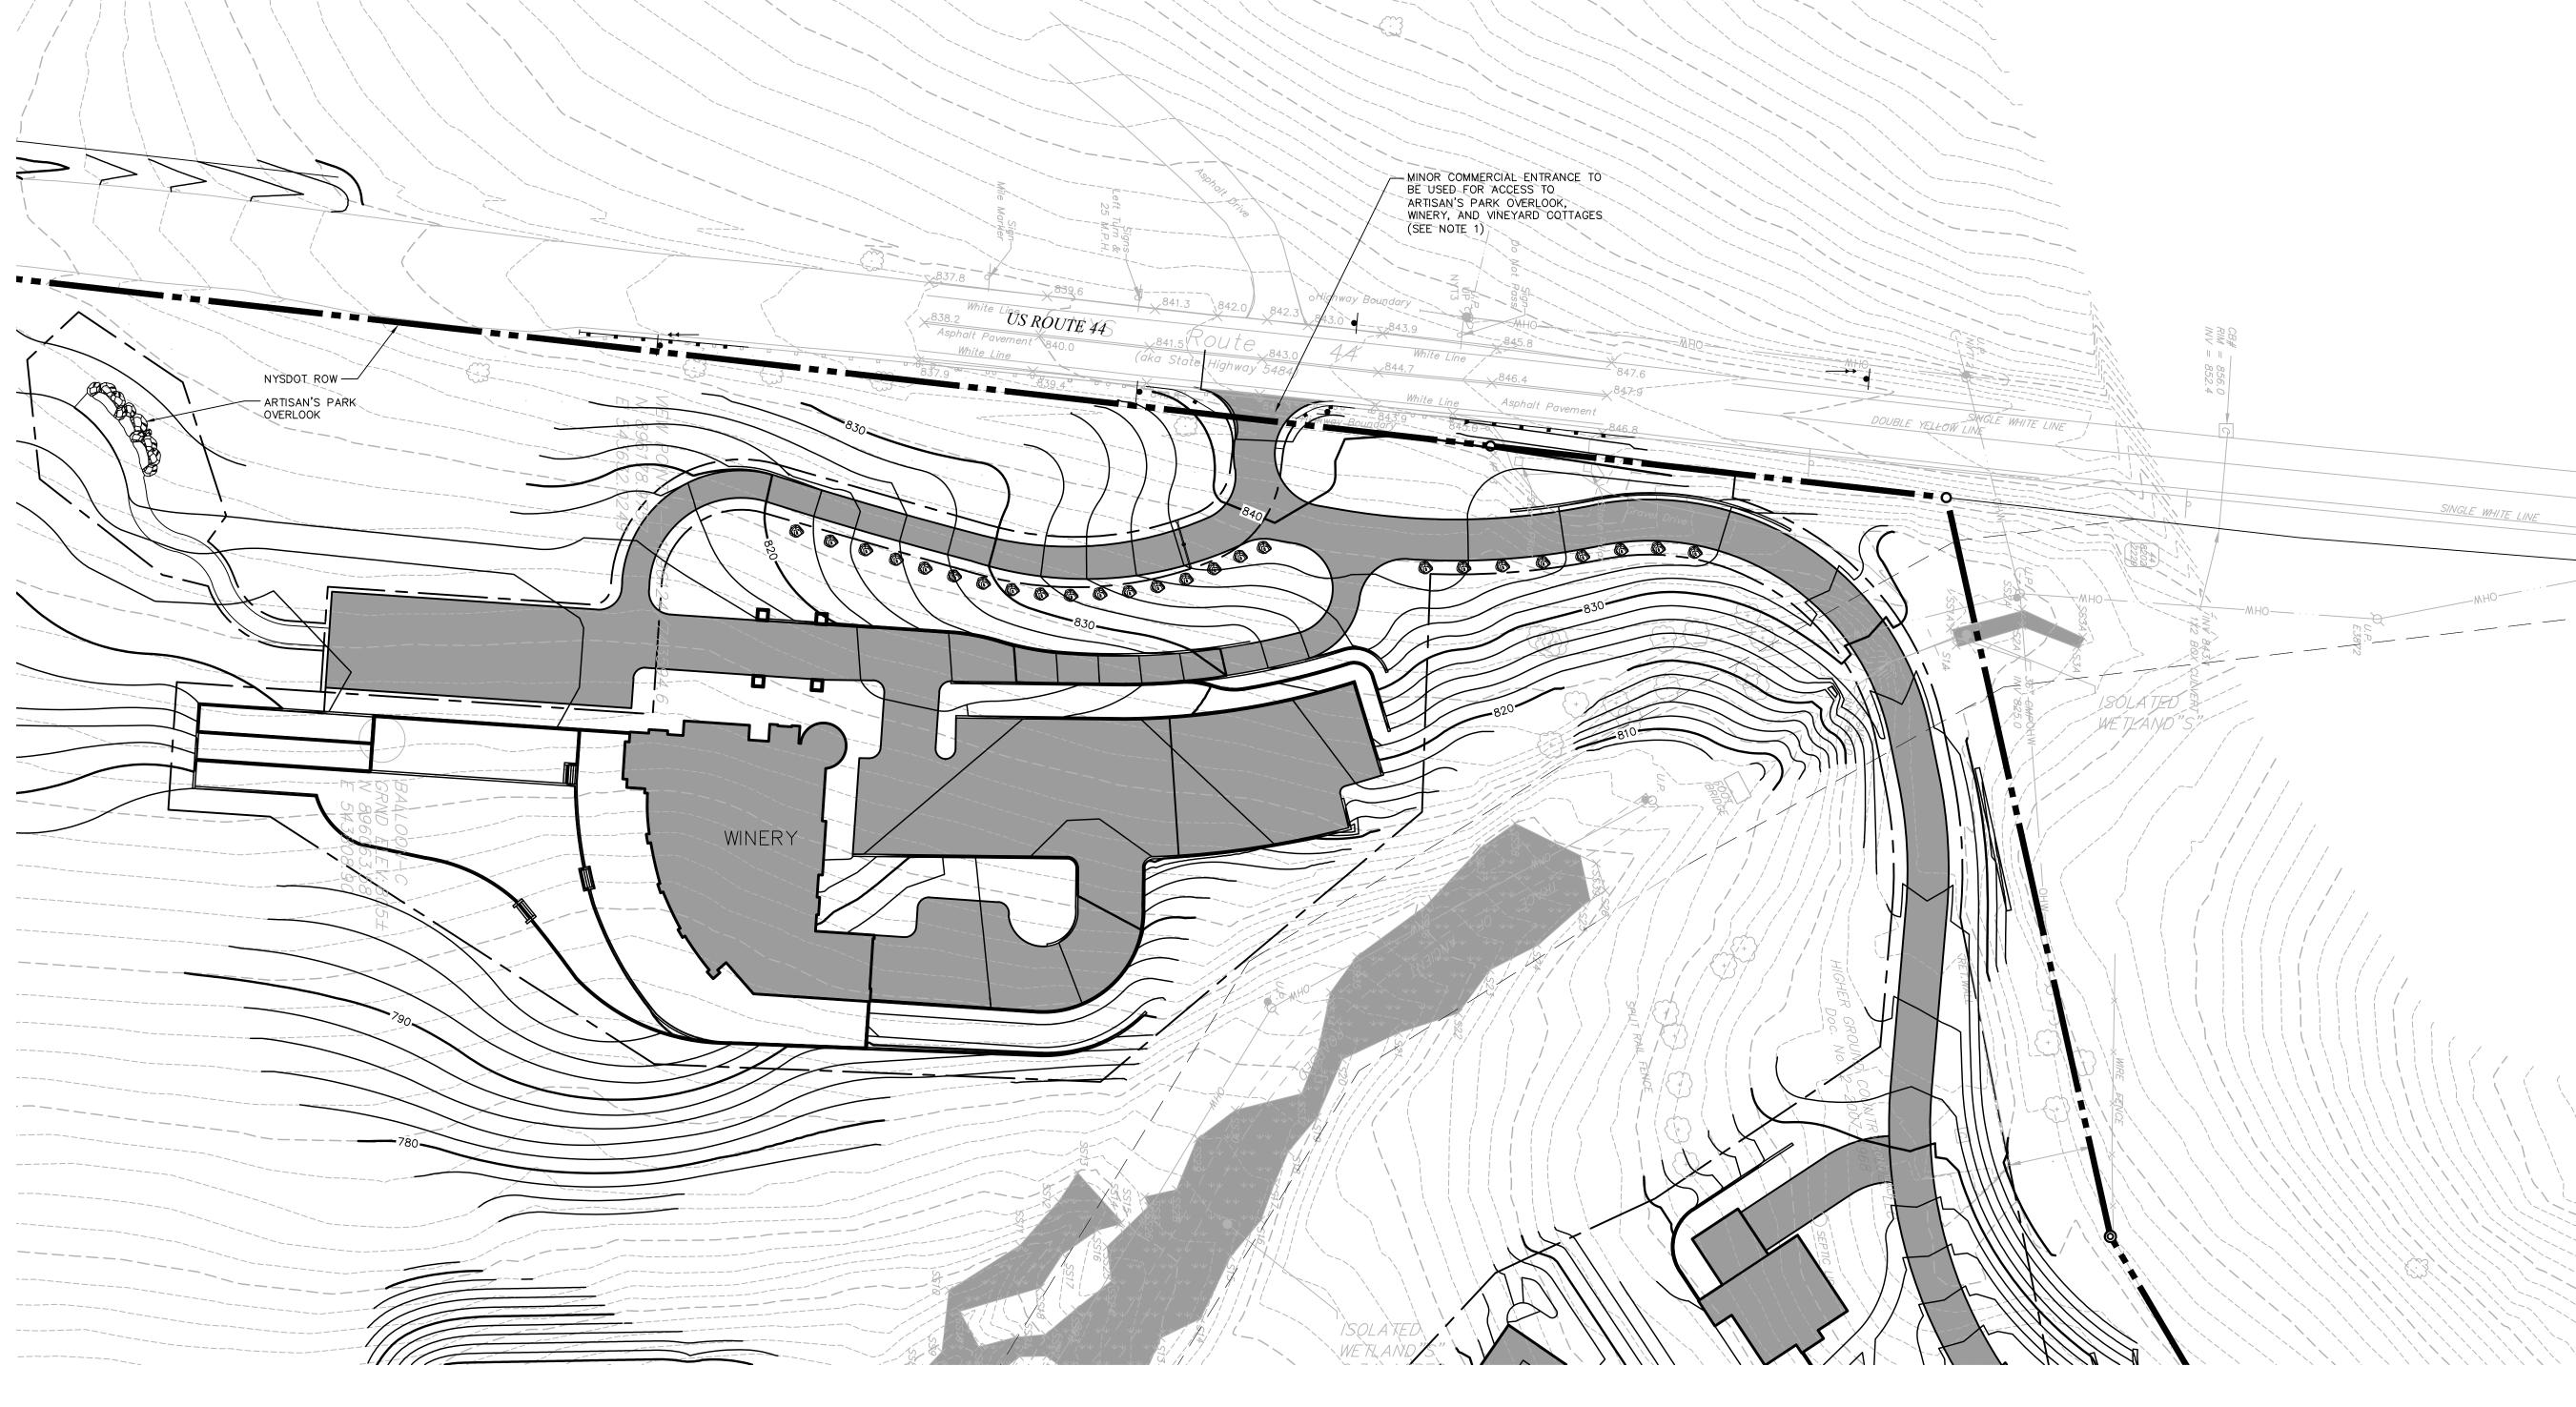General Plan 4

General Plan 4 MDP

GP-41

ate July 31, 2014

Sheet 7 18 1

Amanda C. DeCesare
N.Y. Professional Engineer
NY Lic. No. 084690


HAIRPIN TURN




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Silo Ridge Resort Community

4651 Route 22 Amenia, New York

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Drawing Title

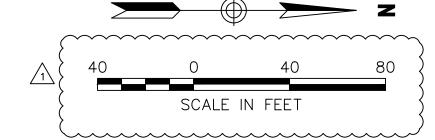General Plan 5 Option 1

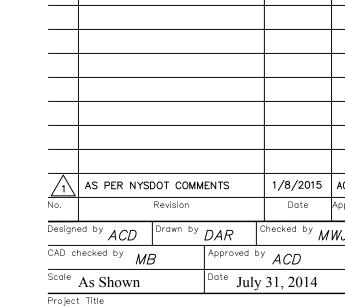Amanda C. DeCesare N.Y. Professional Engineer NY Lic. No. 084690

Notes:

A USE AND OCCUPANCY PERMIT IS REQUIRED FOR THE UTILITIES WITHIN THE NYSDOT RIGHT OF WAY (REFER TO DETAIL ON SHEET MD-2).

\\VHB\PROJ\WHITEPLAINS\29011.00 APWAN\CAD\LD\PLANSET\NYSDOT PERMIT PLANS\29011.00-NYSDOT-PLOT

29011..00-NYSDOT-PLOT..DWG


SOUTH ENTRANCE


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Silo Ridge Resort Community

4651 Route 22 Amenia, New York

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Not Approved for Construction

General Plan 6

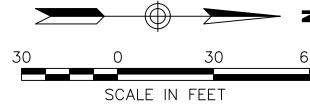Amanda C. DeCesare N.Y. Professional Engineer NY Lic. No. 084690

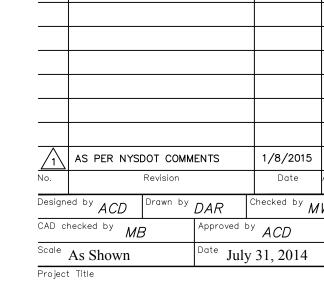
INGRESS AND EGRESS.

A GATE ARM WILL BE PROVIDED JUST BEYOND THE ENTRANCE TO
THE GOLF MAINTENANCE FACILITY. EMPLOYEES, RESIDENTS, AND
EMERGENCY SERVICES WILL HAVE A KEY PASS WHICH WILL PROVIDE
ACCESS THROUGH THE GATE ARM. THE GATE ARM CAN ALSO BE
CONTROLLED BY THE GOLF MAINTENANCE FACILITY.

Project Number 29011.00

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Work Zone Traffic Control Plan - Lane Shift For Proposed Road Widening

N.T.S.

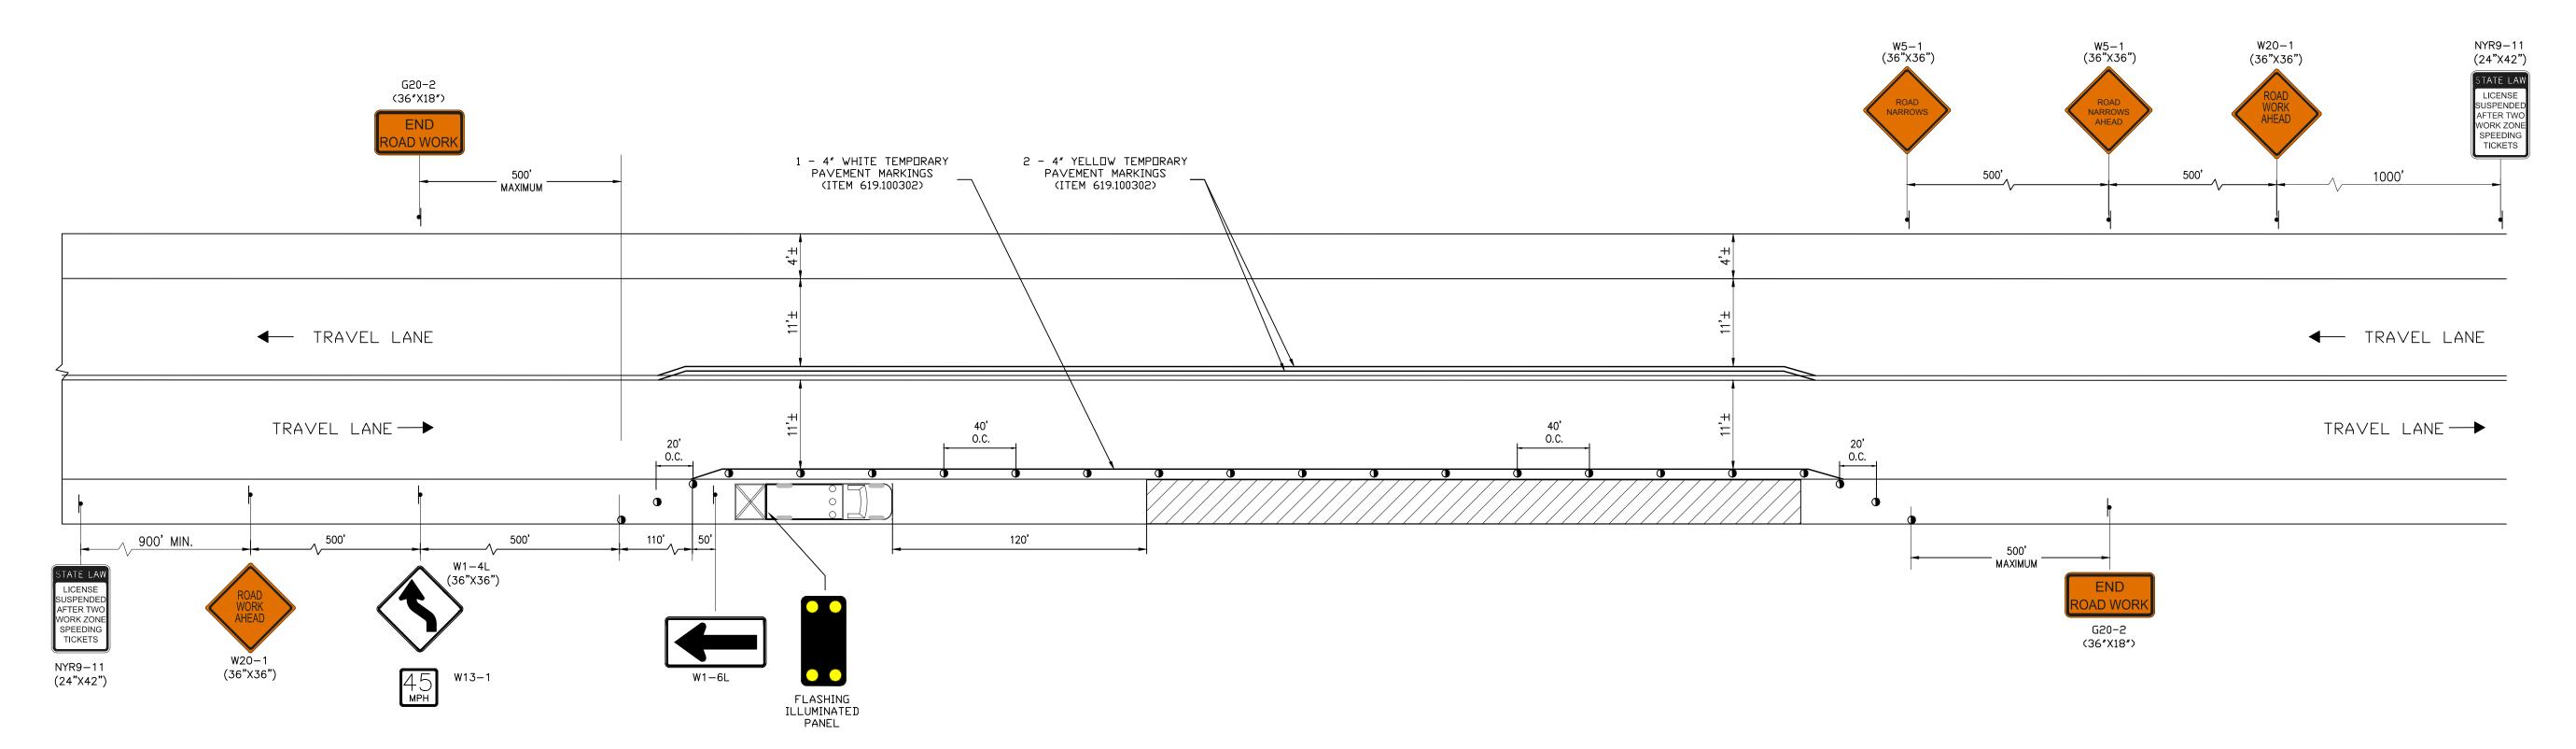1. COVER OR REMOVE ALL CONFLICTING PAVEMENT MARKINGS AND SIGNS PER ITEM 619.080202 OR 619.0803.

Notes:

2. SIGNS ARE ALL SIZED FOR A CONVENTIONAL ROAD PER NYSDOT STANDARD SHEET 619-12.

N.T.S.

FLASHING ILLUMINATED PANEL

DRUM

WORK AREA

DIRECTION OF TRAFFIC

Traffic Control
Plan 1

AS PER NYSDOT COMMENTS

Designed by ACD Drawn by DAR

Resort Community

Not Approved for Construction

Drawing Title

Scale N.T.S.

Silo Ridge

4651 Route 22

Amenia, New York

NYSDOT Permit

Work Zone

Project Title

WZ-1
Sheet 11 18

Checked by MWJ

Approved by ACD


July 31, 2014

Amanda C. DeCesare
N.Y. Professional Engineer
NY Lic. No. 084690

29011—NYSDOT—WZ.DWG

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1. COVER OR REMOVE ALL CONFLICTING PAVEMENT MARKINGS AND SIGNS PER ITEM 619.080202 OR 619.0803.

2. SIGNS ARE ALL SIZED FOR A CONVENTIONAL ROAD PER NYSDOT STANDARD SHEET 619-12.

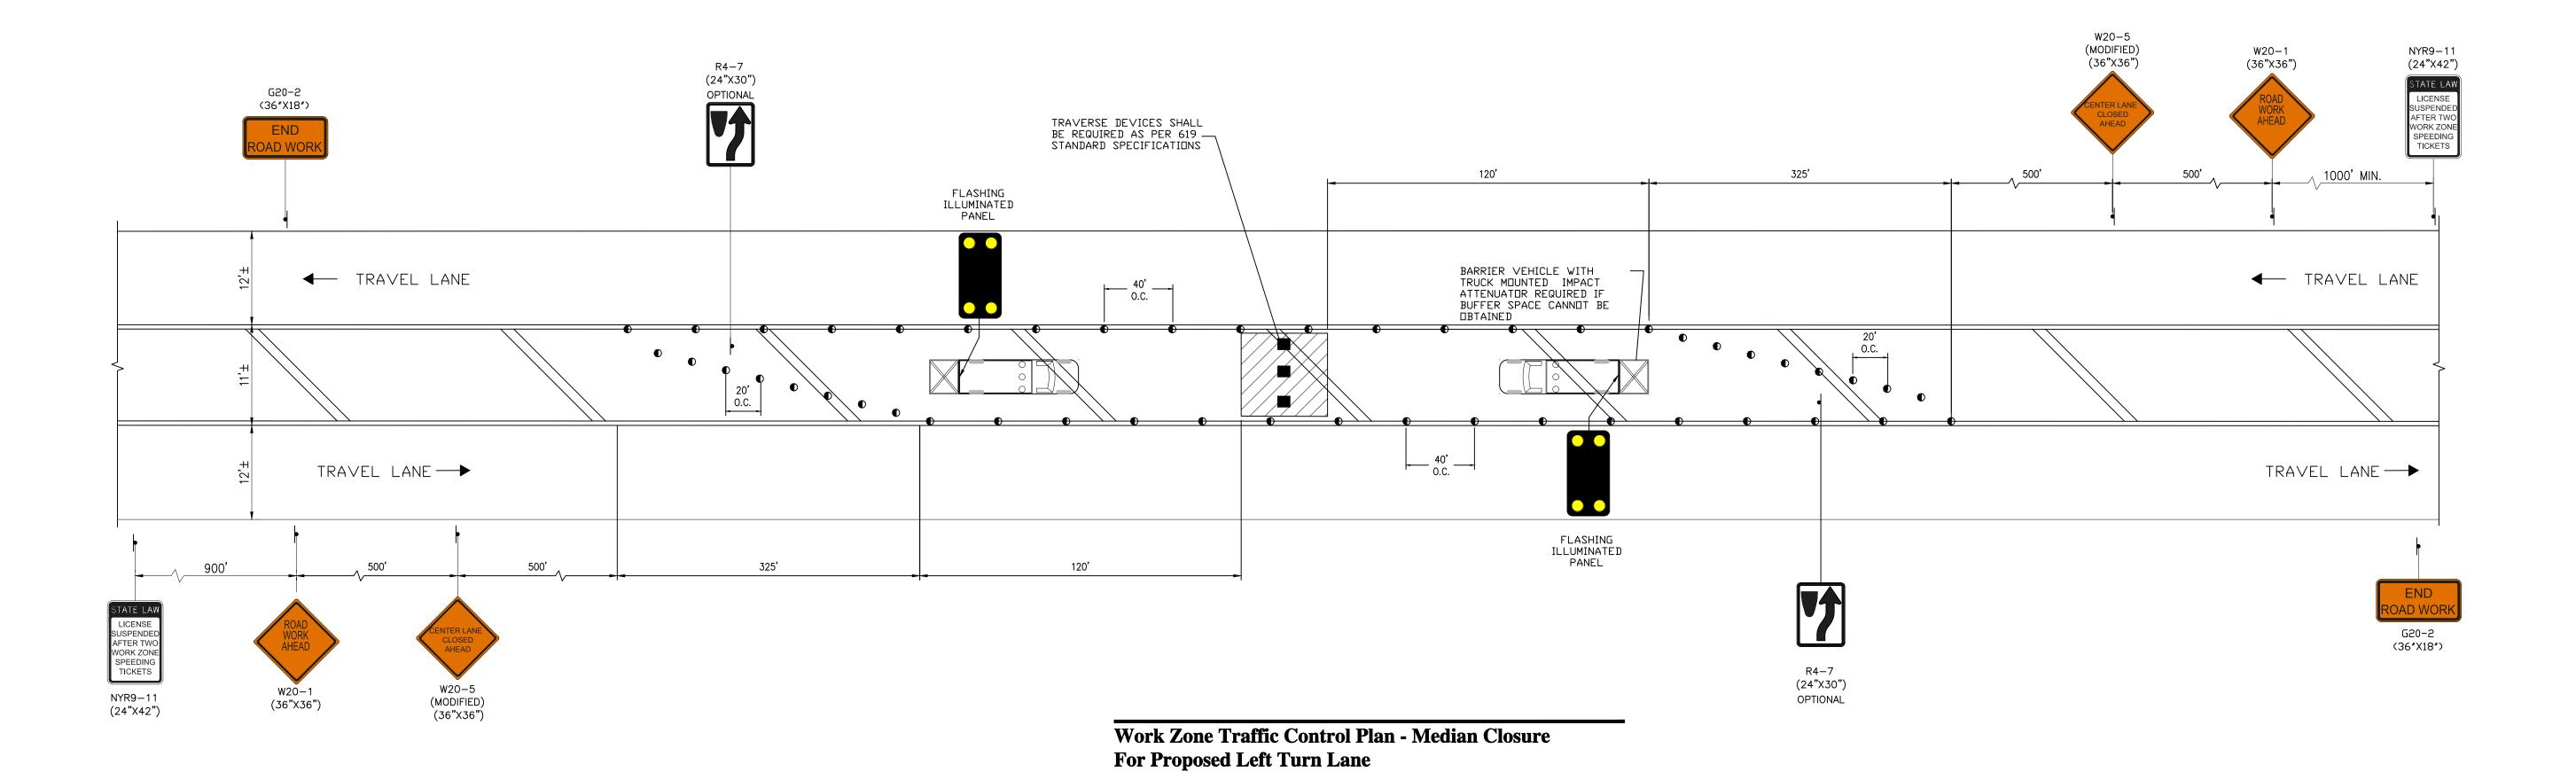Notes:

LEGEND N.T.S. FLASHING ILLUMINATED PANEL DRUM WORK AREA

DIRECTION OF TRAFFIC

1	AS PER NYSI	ООТ СОММ	ENTS	1/8/2015	ACI
No.		Revision		Date	App
Design	ed by ACD	Drawn by	DAR	Checked by \hbar	1WJ
CAD c	hecked by <i>ME</i>	3	Approved b	OY ACD	
Scale	N.T.S.		Date July	v 31. 2014	

Silo Ridge Resort Community

4651 Route 22 Amenia, New York

NYSDOT Permit

Not Approved for Construction

Drawing Title

Work Zone Traffic Control Plan 2

Amanda C. DeCesare N.Y. Professional Engineer NY Lic. No. 084690

29011-NYSDOT-WZ..DWG


Notes:

SIGNS ARE ALL SIZED FOR A CONVENTIONAL ROAD PER NYSDOT STANDARD SHEET 619–12.

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Work Zone Traffic Control Plan - Lane Closure For Proposed Curb Cut

N.T.S.

N.T.S.

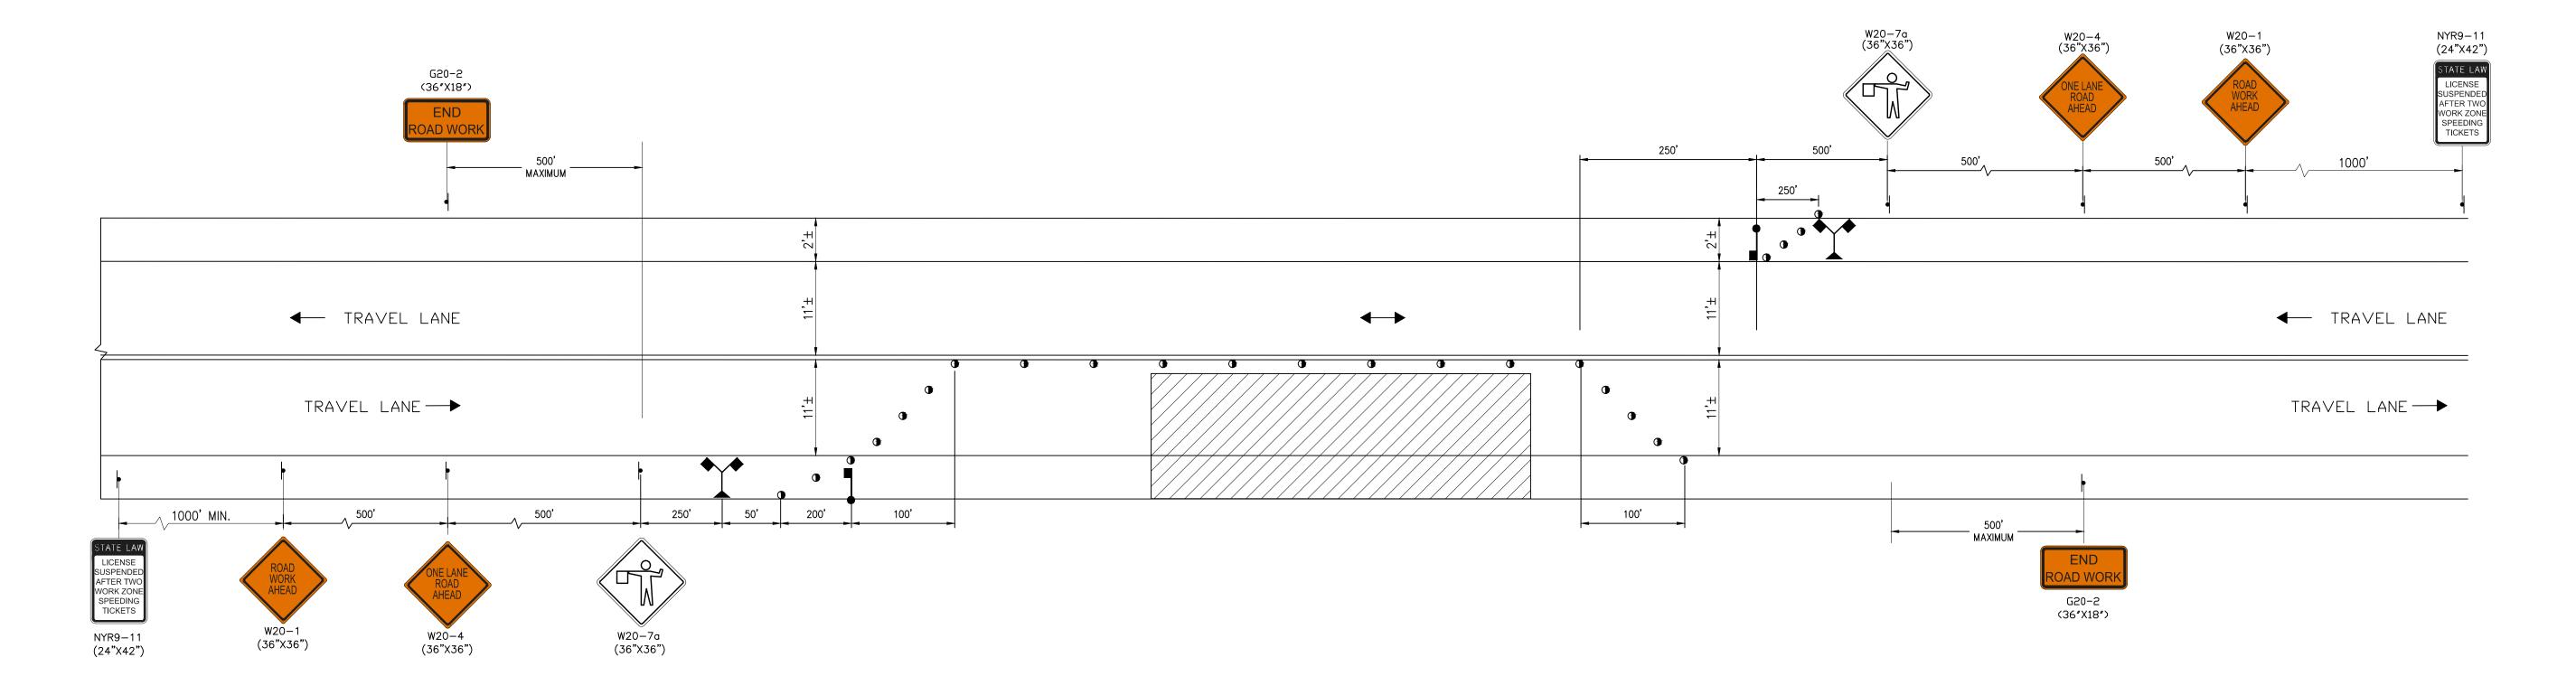DRUM

WORK AREA

DIRECTION OF TRAFFIC

$\overline{1}$	AS PER NYS	рот сомм	ENTS	1/8/2015	A
No.		Revision		Date	Ар
Design	ed by ACD	Drawn by	DAR	Checked by N	l W.
CAD cl	hecked by <i>ME</i>	3	Approved b	OY ACD	
Scale	N.T.S.		Date July	31, 2014	
Project	t Title		•		

Silo Ridge Resort Community

4651 Route 22 Amenia, New York

NYSDOT Permit

Not Approved for Construction

Drawing Title

Work Zone
Traffic Control
Plan 3

Drawing Number


WZ-3


Sheet 13 18 18

Project Number 29011 00

Amanda C. DeCesare
N.Y. Professional Engineer
NY Lic. No. 084690

29011.00

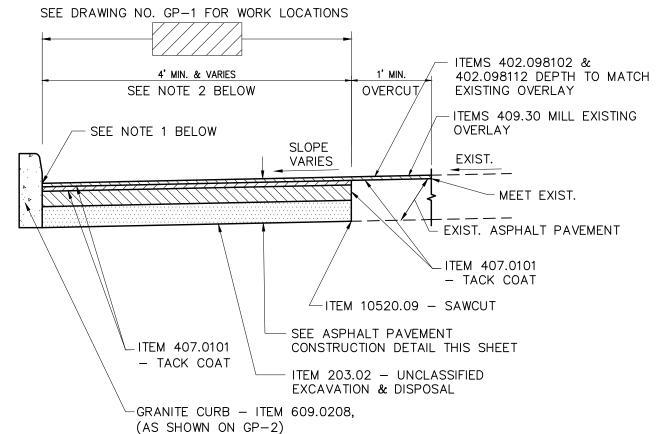


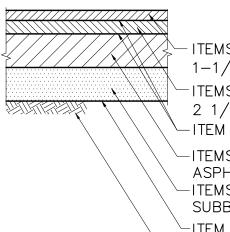


-ITEMS 402.098102 & 402.098112 -1-1/2" TOP COURSE, SUPERPAVE HMA -ITEMS 402.198902 & 402.198912 -2 1/2" BINDER COURSE, SUPERPAVE HMA -ITEM 407.0101 - TACK COAT, SEE NOTE -ITEMS 402.378902 & 402.378912 - 6" ASPHALT CONCRETE BASE COURSE —ITEMS 304.10119917 → 12" SUBBASE COURSE └ITEM 203.02 - UNCLASSIFIED EXCAVATION & DISPOSAL — SUITABLE SUBGRADE

Superpave HMA Asphalt Pavement Detail

PLACE TACK COAT BETWEEN EVERY ASPHALT LIFT AND AT THE JOINTS BETWEEN NEW AND EXISTING ASPHALT PAVEMENT EDGES.

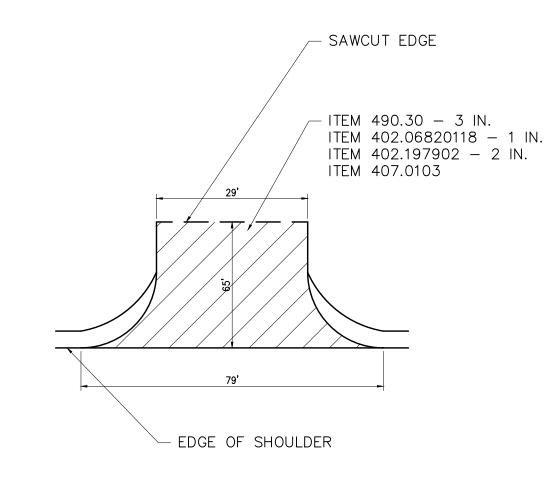

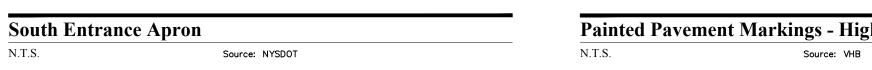

LD_171


FEROSION CONTROL BLANKET

-6" BLANKET EMBEDMENT (TYP)


Source: VHB

Drainage Swale

N.T.S.

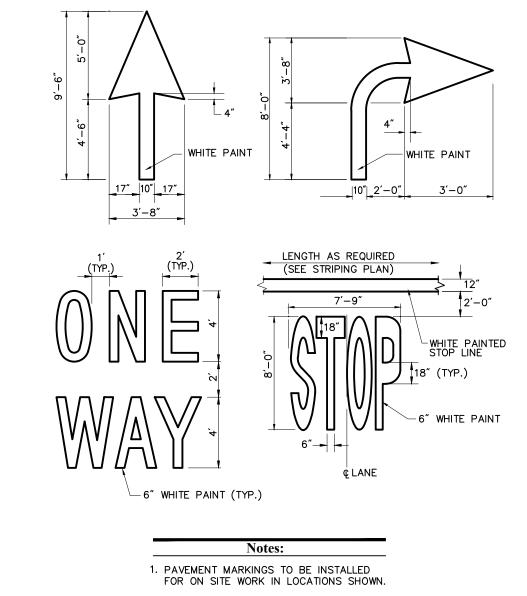

arkings - Highway	1/1
Source: VHB	LD_55
	<u> </u>

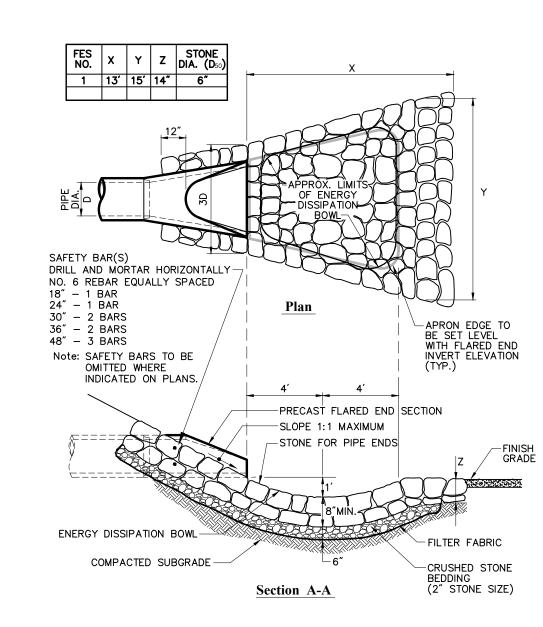

Flared End Secti	ion (FES) with Stone Protection	5,
NTS	()	

AS PER NYSDOT COMMENTS Jesigned by ACD Drawn by DAR oproved by ACD Scale As Shown te July 31, 2014

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& Landscape Architecture, P.C.

Silo Ridge **Resort Community**

4651 Route 22 Amenia, New York

NYSDOT Permit

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Drawing Title


Miscellaneous Details


29011.00

29011..00-NYSDOT-DT..DWG


Amanda C. DeCesare N.Y. Professional Engineer


NY Lic. No. 084690

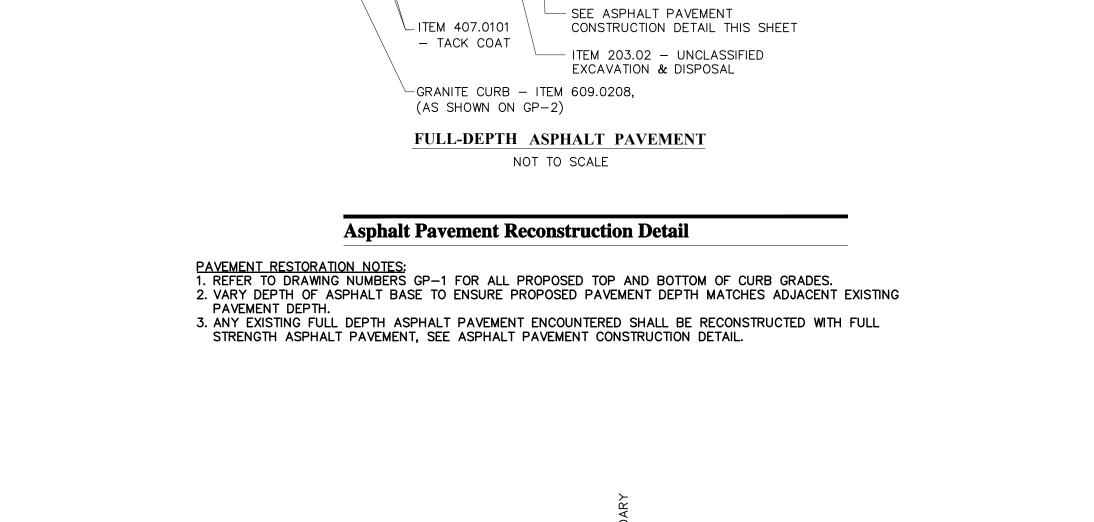

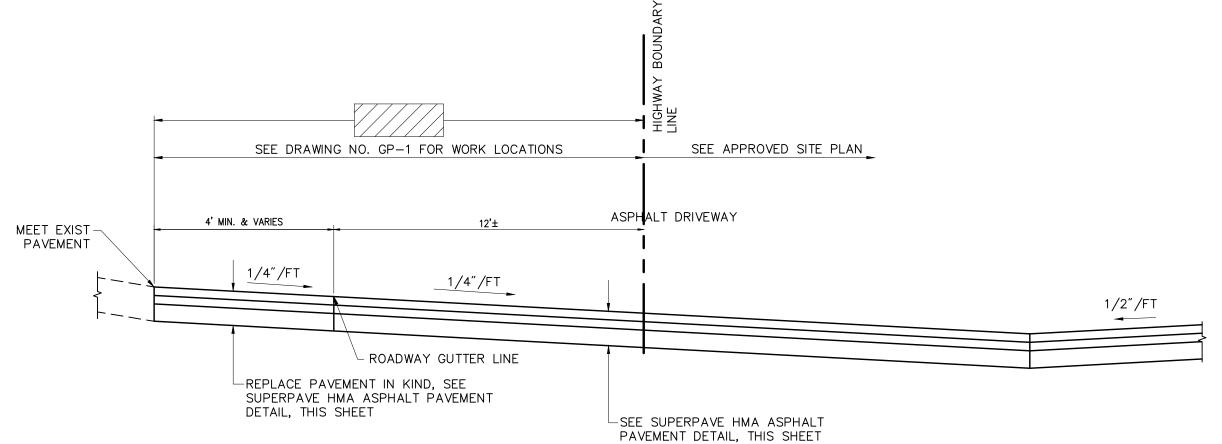

Typical Driveway Detail Section

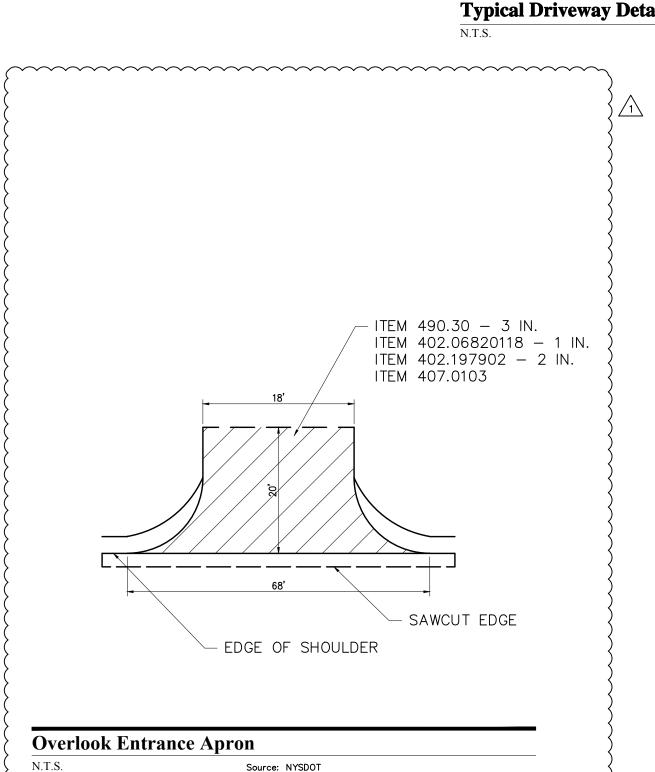

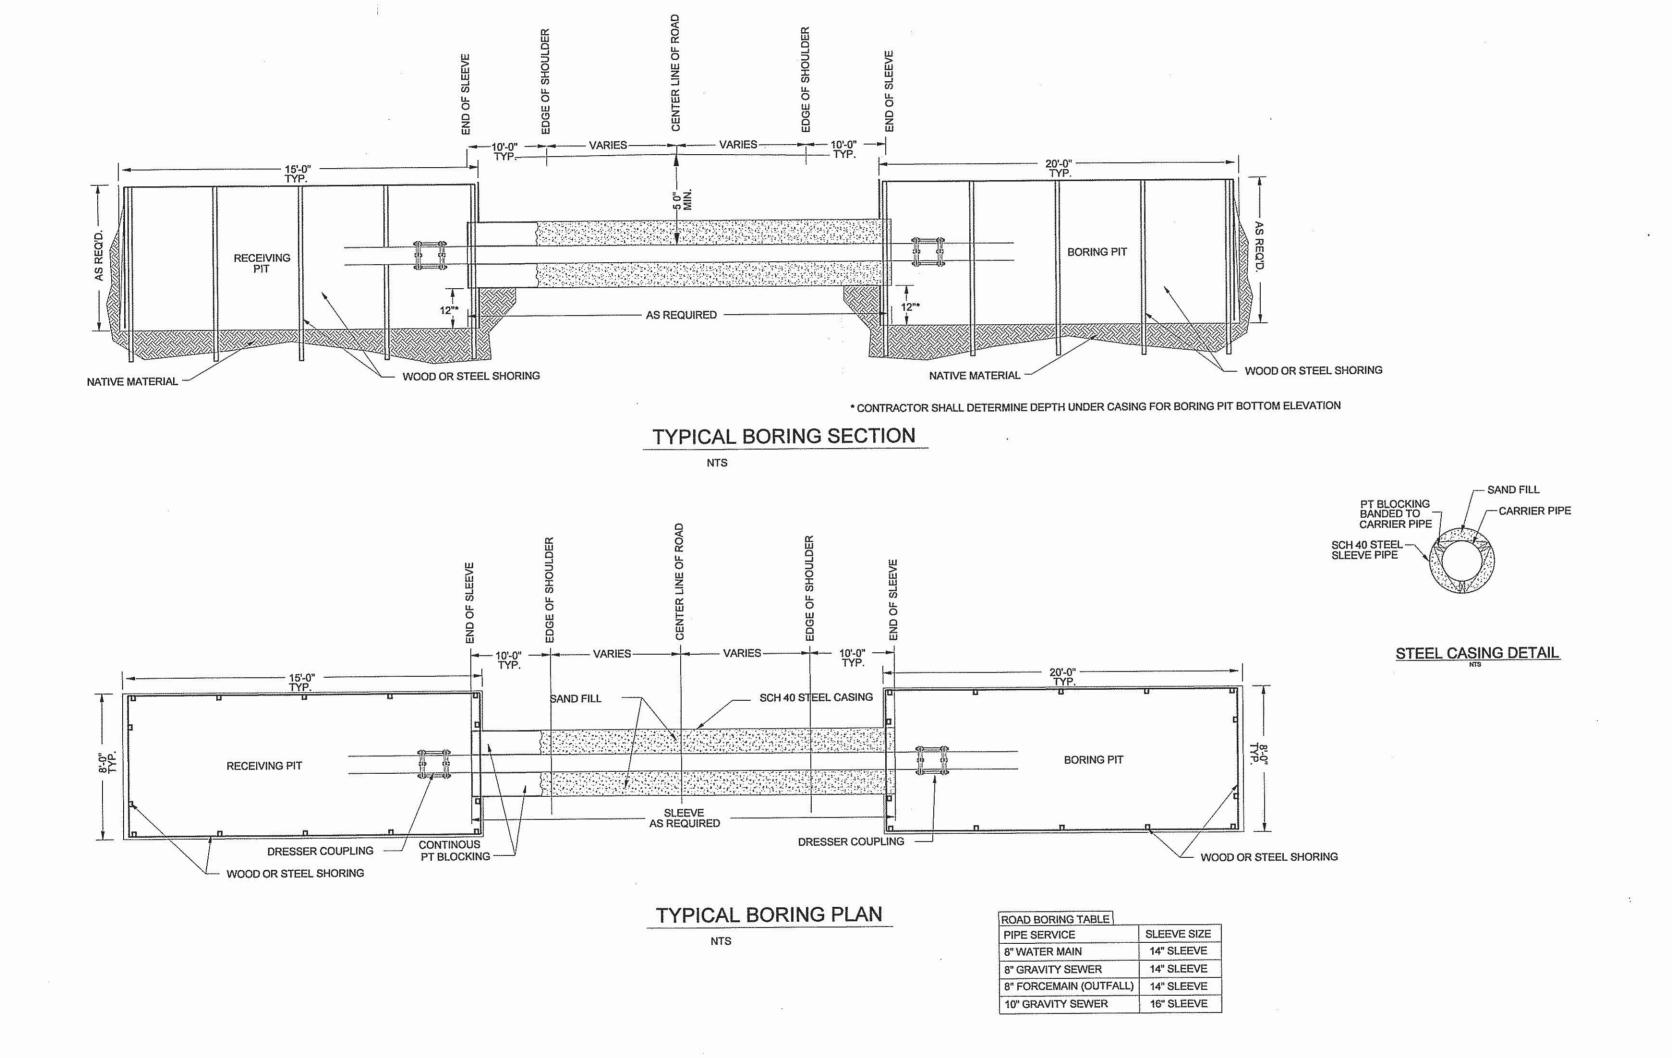

NOTE: ALL PIPES SHALL BE INSTALLED IN SCH 40 STEEL CASING, PRESSURE TREATED BLOCKING SHALL BE ADJUSTED FOR SPECIFIED PIPE DIAMETER NYSDOT HIGHWAY WORK PERMIT AND INSURANCE AS REQUIRED TO BE SUPPLIED BY OTHERS.

CONTRACTOR SHALL PROVIDE DETAILED SHORING DRAWINGS, ALL DRAWINGS SHALL BE STAMPED BY A NYS LICENSED ENGINEER

DRAWING TITLE:

GENERAL SITE DETAILS

CLIENT:


SILO RIDGE RESORT COMMUNITY
AMENIA, N.Y.


OF SECTION 7205 SUBDIVISION 2 OF THE NEW YORK STATE EDUCATION LAW.


CEDARWOOD
ENGINEERING
SERVICES, PLLC
DELAWARE OPERATIONS, INC.
CIVIL & ENVIRONMENTAL ENGINEERING
AND FACILITY OPERATIONS, INC.
B-12 DIETZ STREET, SUITE 303, ONEONTA, NY 607.432.8073
246 MAIN STREET, PO BOX 203, NOENTA, NY 607.432.8073
JFS


CHECKED BY:
JFS



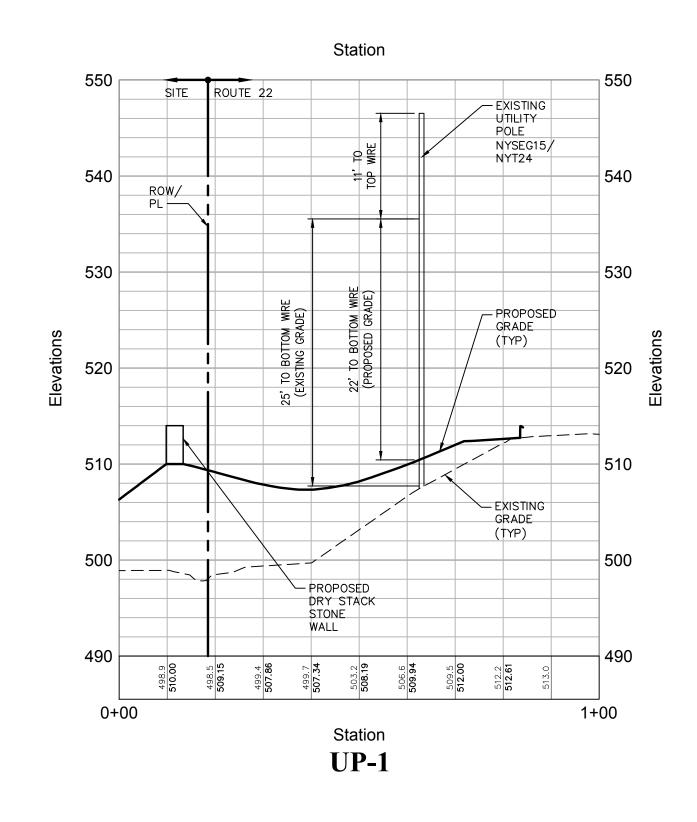

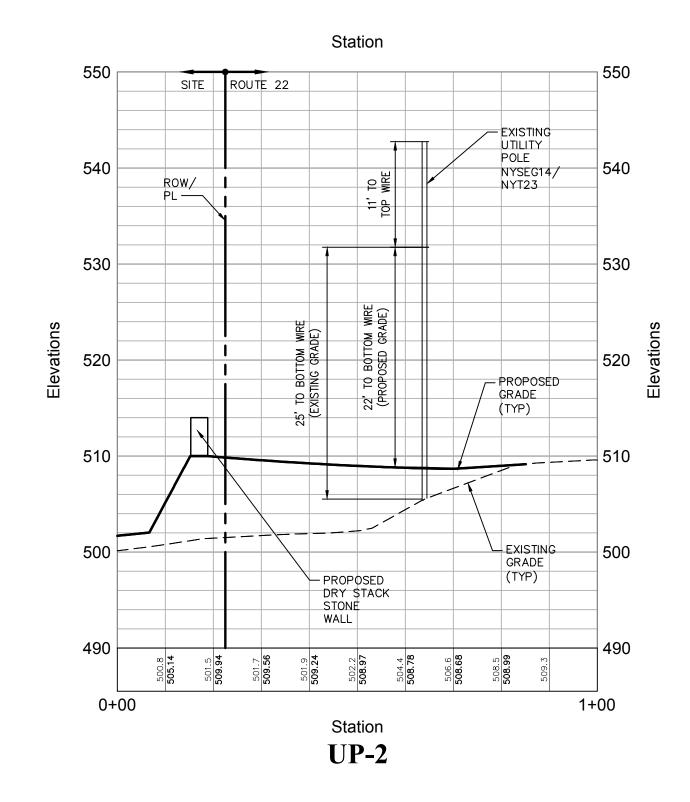

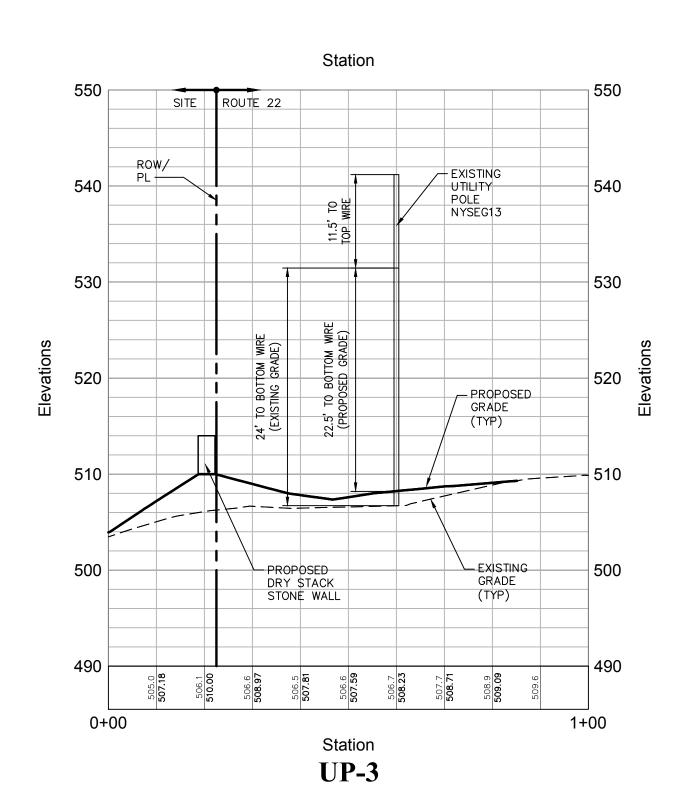

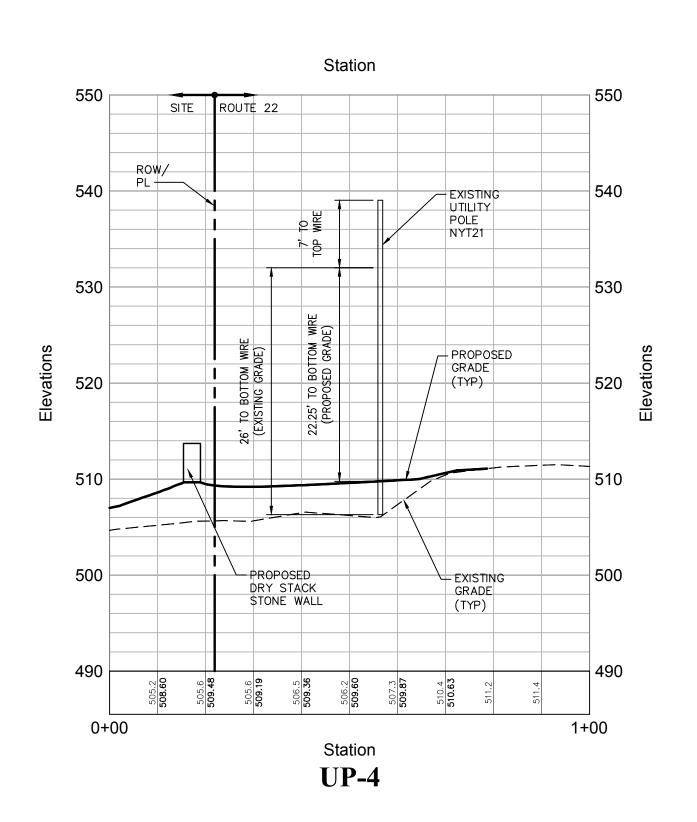

FILL CROSS SECTIONS AT MAIN ENTRANCE


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	HORIZ	ONTAL	
20	0	20	40
10	0	10	20
	VER ⁻	TICAL	
	SCALE	IN FEET	



Silo Ridge Resort Community

4651 Route 22 Amenia, New York

NYSDOT Permit

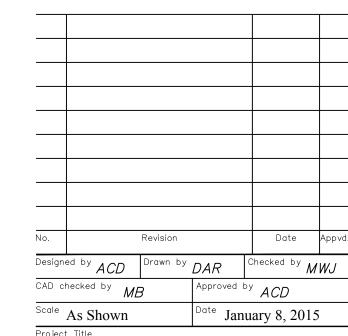Construction
Drawing Title

Notes:

1. SEE SHEET GP-1 FOR PLAN VIEW.

Miscellaneous Details 3


Drawing Number

Sheet of 16 18


Amanda C. DeCesare
N.Y. Professional Engineer
NY Lic. No. 084690

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Project Number
29011.00

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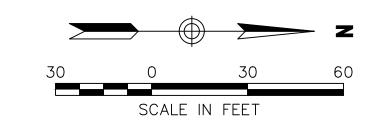


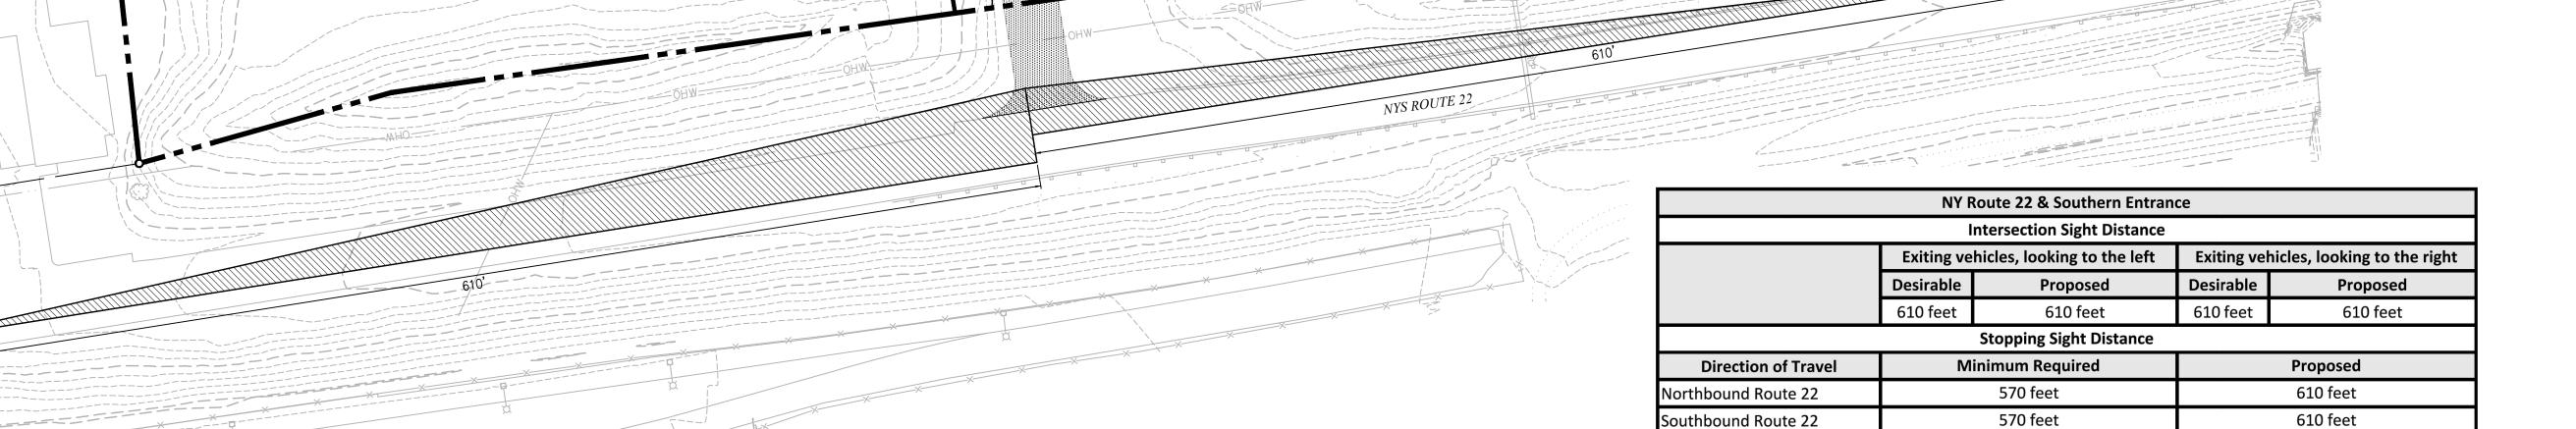SOUTH ENTRANCE - SIGHT DISTANCE TRIANGLES

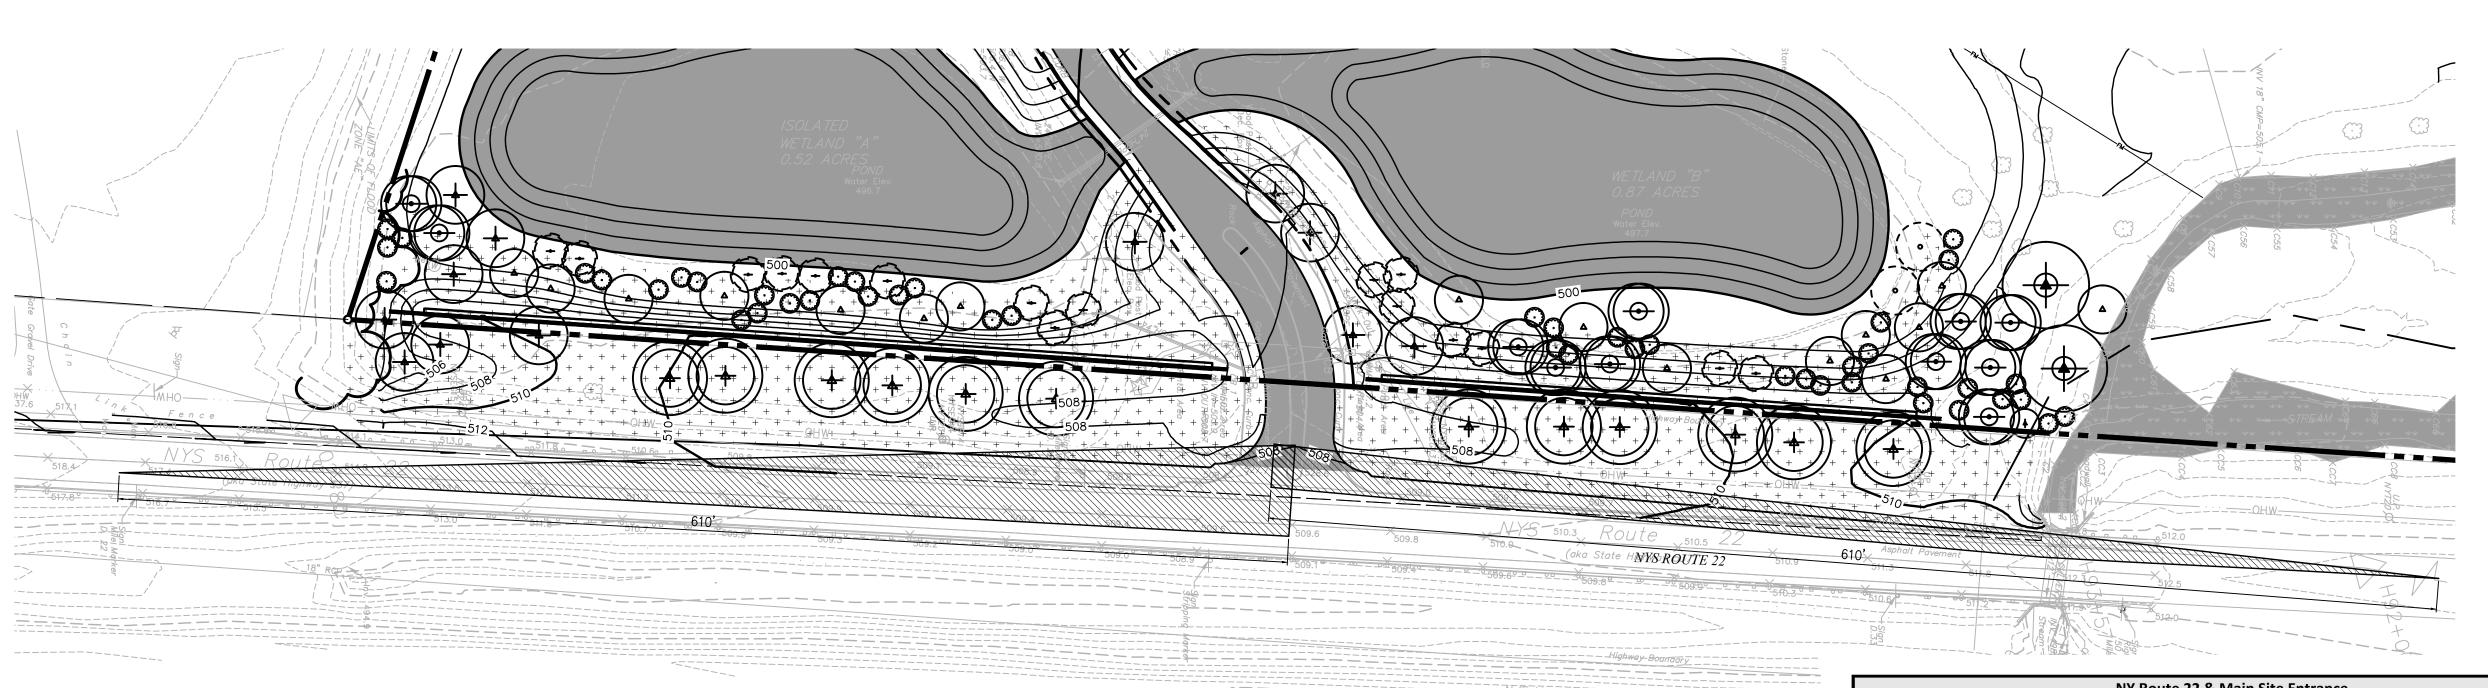

MAIN ENTRANCE - SIGHT DISTANCE TRIANGLES

	NY R	oute 22 & Main Site Entran	ice			
Intersection Sight Distance						
	Exiting ve	hicles, looking to the left	Exiting vehicles, looking to the right			
	Desirable	Proposed	Desirable	Proposed		
	610 feet	610 feet	610 feet	610 feet		
		Stopping Sight Distance				
Direction of Travel	М	Minimum Required		Proposed		
Northbound Route 22		570 feet	610 feet			
Southbound Route 22		570 feet	610 feet			



).		Revisio	on		Do	ıte	Арр
							\top

Silo Ridge Resort Community

4651 Route 22
Amenia, New York

NYSDOT Permit

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Drawing Title

Sight Distance Triangles 1

Sheet of 17 18

anda C. DeCesare

US ROUTE 44



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	NY Route	44 & Vineyard Estates Ent	trance		
	Int	tersection Sight Distance			
	Exiting vehi	icles, looking to the left	Exiting vel	hicles, looking to the right	
	Desirable	Proposed	Desirable	Proposed	
	610 feet	610 feet	610 feet	645 feet	
	S	Stopping Sight Distance			
Direction of Travel	Min	imum Required		Proposed	
Eastbound Route 44		645 feet*	645 feet		
Westbound Route 44		500 feet*	610 feet		

VINEYARD ESTATES ENTRANCE - SIGHT DISTANCE TRIANGLES



			D Z		NY Route 44 & Winery Restaurant/Over	
					Intersection Sight Distance	
					Exiting vehicles, looking to the left	
					Desirable Proposed	Desirable
					610 feet 610 feet	610 feet
	7				Stopping Sight Distance	
	State of the state			Direction of Travel	Minimum Required	Pr
	Market State			Northbound Route 44	530 feet*	6
	P.H. H.			Southbound Route 44	600 feet*	6
830	841.3 842.0 842.3 843.0 843.9	847.6 847.6 847.6	850.00 BH = 856.00	SINGLE WHITE LINE MHO ESSENTE	MHC MHC NYT 488780	

|--|

No.	Revision			Date	Appvd	
Designed by ACD Drawn by			DWB	Checked by	иWJ	
CAD c	CAD checked by MB			ACD		
Scale	Scale As Shown			Date January 8, 2015		

Silo Ridge Resort Community

4651 Route 22 Amenia, New York

Exiting vehicles, looking to the right

Proposed

610 feet

610 feet

Proposed

610 feet

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Sight Distance Triangles 2

Amanda C. DeCesare N.Y. Professional Engineer NY Lic. No. 084690

29011..00-NYSDOT-PLOT..DWG